

CLEARHILLS FIREHALL

LOT 84 & 85, BLOCK 1, PLAN 07262595, CLEARDALE, CLEARHILLS COUNTY, AB

CIVIL

2425-008-DD

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SECTION 01001 GENERAL INSTRUCTIONS

- DOCUMENTS REQUIRED
- A. MAINTAIN AT JOB SITE, ONE OF EACH OF THE FOLLOWING: CONTRACT DRAWINGS
- SPECIFICATIONS.
- ADDENDA. REVIEWED SHOP DRAWINGS. CHANGE ORDERS.
- OTHER MODIFICATIONS TO CONTRACT.
- FIELD TEST REPORTS.
- COPY OF APPROVED WORK SCHEDULE. MANUFACTURERS INSTALLATION AND APPLICATION INSTRUCTIONS.

2. CONTRACTOR'S USE OF SITE

- A. USE OF THE SITE: EXCLUSIVE AND COMPLETE FOR EXECUTION OF WORK EXCEPT AS
- ACCESS FOR INSTALLATION OF SITE UTILITY SERVICES CONTRACTORS. ACCESS FOR OTHER CONTRACTORS HAVING A SEPARATE CONTRACT WITH THE
- B. DO NOT UNREASONABLY ENCUMBER SITE WITH MATERIALS OR EQUIPMENT.
- C. MOVE STORED PRODUCTS OR EQUIPMENT WHICH INTERFERE WITH OPERATION OF OTHER CONTRACTORS
- D. OBTAIN AND PAY FOR USE OF ADDITIONAL STORAGE OR WORK AREAS NEEDED FOR
- E. MAINTAIN SAFETY HELMETS ON THE JOB SITE, READY FOR USE.
- F. CONFINE APPARATUS. THE STORAGE OF MATERIALS. AND THE OPERATION OF

UNREASONABLY ENCUMBER THE PREMISES WITH MATERIALS.

G. ENFORCE THE OWNER'S INSTRUCTIONS REGARDING SIGNS, ADVERTISEMENTS, FIRES AND SMOKING

WORKMEN TO LIMITS INDICATED BY LAW OR BY DIRECTION OF THE OWNER. DO NOT

3. ACCESS TO THE WORK

- A. THE CONSULTANT, THE OWNER OR OTHER AUTHORIZED OFFICERS DELEGATED WILL HAVE ACCESS TO THE WORK, OR OTHER PLACES WHERE WORK IS BEING FABRICATED IN CONNECTION WITH THE CONTRACT, AT ALL TIMES FOR THE PURPOSES OF INSPECTION AND EXAMINATION OF WORKMANSHIP AND MATERIALS.
- 4. CODES AND STANDARDS
- A. PERFORM WORK IN ACCORDANCE WITH THE PROVINVIAL BUILDING CODE LATEST EDITION AND ANY OTHER CODE OF PROVINCIAL OR LOCAL APPLICATION PROVIDED THAT IN ANY CASE OF CONFLICT OR DISCREPANCY, MORE STRINGENT REQUIREMENTS
- B. REFER TO INDIVIDUAL SECTIONS OF SPECIFICATIONS FOR PARTICULAR REFERENCE OF SPECIALLY APPLICABLE CODES AND STANDARDS FOR THE PERFORMANCE OF THE
- C. MEET OR EXCEED REQUIREMENTS OF SPECIFIED STANDARDS, CODES AND REFERENCED DOCUMENTS

5. SETTING OUT OF WORK

- A. ASSUME FULL RESPONSIBILITY FOR AND EXECUTE COMPLETE LAYOUT OF WORK TO LOCATIONS, LINES AND ELEVATIONS INDICATED.
- B. THE CARE OF THE WORKS SHALL REST WITH THE CONTRACTOR.
- C. BE RESPONSIBLE FOR LOSS OR DAMAGE TO THE BUILDING AND/OR STORED MATERIALS
- AND FOR DAMAGE CAUSED BY FROST OR INCLEMENT WEATHER. D. PROVIDE DEVICES NEEDED TO LAYOUT AND CONSTRUCT WORK.
- E. SUPPLY STAKES AND OTHER SURVEY MARKERS REQUIRED FOR LAYOUT WORK.
- 6. LOCATION OF EQUIPMENT AND FIXTURES
- A. LOCATION OF EQUIPMENT, FIXTURES AND OUTLETS INDICATED OR SPECIFIED ARE TO BE CONSIDERED AS APPROXIMATE.
- B. LOCATE EQUIPMENT, FIXTURES AND DISTRIBUTION SYSTEMS TO PROVIDE MINIMUM INTERFERENCE AND MAXIMUM USABLE SPACE AND IN ACCORDANCE WITH MANUFACTURER'S RECOMMENDATIONS FOR SAFETY, ACCESS AND MAINTENANCE.
- JLTANT OF IMPENDING INSTALLATION AND OBTAIN HIS APPROVAL FOR ACTUAL LOCATION.
- D. SUBMIT A FIELD DRAWING TO INDICATE RELATIVE POSITION OF VARIOUS SERVICES AND EQUIPMENT WHEN REQUESTED BY CONSULTANT.
- 7. CUTTING, FITTING AND PATCHING
- A. EXECUTE CUTTING (INCLUDING EXCAVATION), FITTING AND PATCHING REQUIRED TO MAKE WORK FIT PROPERLY TOGETHER INCLUDING SUCH WORK AS REQUIRED FOR ELECTRICAL AND MECHANICAL SERVICES AND FACILITIES.
- B. WHERE NEW WORK CONNECTS WITH EXISTING AND WHERE EXISTING WORK IS
- ALTERED, CUT, PATCH AND MAKE GOOD TO MATCH EXISTING WORK. C. OBTAIN CONSULTANT'S WRITTEN APPROVAL BEFORE CUTTING, BORING OR SLEEVING
- LOAD-BEARING MEMBERS.
- D. MAKE CUTS WITH CLEAN, TRUE, SMOOTH EDGES. MAKE PATCHES INCONSPICUOUS IN FINAL ASSEMBLY
- E. FIT WORK AIRTIGHT TO PIPES, SLEEVES, DUCTS AND CONDUITS AND MAINTAIN INTEGRITY OF ALL FIRE SEPARATIONS, AIR AND VAPOUR BARRIERS.
- 8. CONCEALMENT
- A. CONCEAL PIPES, DUCTS AND WIRING IN FLOOR, WALL AND CEILING CONSTRUCTION OF FINISHED AREAS EXCEPT WHERE INDICATED OTHERWISE.

9. EXISTING SERVICES

- A. WHERE WORK INVOLVES BREAKING INTO OR CONNECTING TO EXISTING SERVICES CARRY OUT WORK AT TIMES DIRECTED BY GOVERNING AUTHORITIES, WITH MINIMUM OF DISTURBANCE TO PEDESTRIAN AND VEHICULAR TRAFFIC.
- B. BEFORE COMMENCING WORK, ESTABLISH LOCATION AND EXTENT OF SERVICE LINES IN AREA OF WORK AND NOTIFY CONSULTANT OF FINDINGS.
- C. SUBMIT SCHEDULE TO AND OBTAIN APPROVAL FROM OWNER FOR ANY SHUT-DOWN OR CLOSURE OF ACTIVE SERVICE OR FACILITY. ADHERE TO APPROVED SCHEDULE AND PROVIDE NOTICE TO AFFECTED PARTIES. PERFORM ALL WORK WITH MINIMUM INTERRUPTION TO OWNER AND USE OF SERVICES.
- D. WHERE UNKNOWN SERVICES ARE ENCOUNTERED, IMMEDIATELY ADVISE CONSULTANT AND CONFIRM FINDINGS IN WRITING.
- E. REMOVE ABANDONED SERVICE LINES WITHIN 2 M OF STRUCTURES. CAP OR OTHERWISE SEAL LINES AT CUT-OFF POINTS AS DIRECTED BY CONSULTANT.
- F. RECORD LOCATIONS OF MAINTAINED, RE-ROUTED AND ABANDONED SERVICE LINES.
- G. AVOID THERMAL SHOCK TO HEATING SYSTEMS. COORDINATE WITH OWNER DURING PLANNING. CONSTRUCTION AND OPERATION OF TEMPORARY HEATING SYSTEM. INCLUDING TEMPORARY AND TRIAL USAGE.
- H. ENSURE APPROVAL OF TEMPORARY HEATING SYSTEMS FROM BOILER PROTECTION BRANCH - DEPARTMENT OF LABOUR - GOVERNMENT HAVING JURISDICTION.

SECTION 01001 GENERAL INSTRUCTIONS - CONT'D

- 10. ALTERATIONS, ADDITIONS OR REPAIRS TO EXISTING BUILDING
- A. EXECUTE WORK WITH LEAST POSSIBLE INTERFERENCE OR DISTURBANCE TO OCCUPANTS, PUBLIC AND NORMAL USE OF PREMISES. ARRANGE WITH CONSULTANT TO FACILITATE EXECUTION OR WORK.
- B. WHERE SECURITY HAS BEEN REDUCED BY WORK OF CONTRACT, PROVIDE TEMPORARY MEANS TO MAINTAIN SECURITY.
- C. PROVIDE TEMPORARY DUST SCREENS, BARRIERS, WARNING SIGNS IN LOCATIONS WHERE RENOVATION AND ALTERATION WORK IS ADJACENT TO AREAS USED BY PUBLIC OR GOVERNMENT STAFF.
- D. CONTRACTOR SHALL ASSUME RESPONSIBILITY FOR THE CARE, CUSTODY AND CONTROL OF PROPERTY WHICH IS ASSIGNED TO HIM FOR PERFORMANCE OF THE WORK.
- E. CONTRACTOR SHALL ASSUME RESPONSIBILITY FOR AND SHALL MAKE GOOD DAMAGE TO EXISTING PROPERTY ATTRIBUTABLE TO PERFORMANCE OF WORK OF THIS

11. TEMPORARY OR TRIAL USAGE

- A. TEMPORARY OR TRIAL USAGE BY THE OWNER OF MECHANICAL EQUIPMENT AND ELECTRICAL EQUIPMENT SUPPLIED UNDER CONTRACT SHALL NOT REPRESENT
- B. REPAIR TO NEW CONDITION OR REPLACE PERMANENT EQUIPMENT USED TEMPORARILY. C. TAKE RESPONSIBILITY FOR DAMAGE CAUSED BY DEFECTIVE MATERIALS OR
- WORKMANSHIP DURING TEMPORARY OR TRIAL USAGE.

12. ADDITIONAL DRAWINGS

A. CONSULTANT MAY FURNISH ADDITIONAL DRAWINGS TO ASSIST PROPER EXECUTION OF WORK. THESE DRAWINGS WILL BE ISSUED FOR CLARIFICATION ONLY. SUCH DRAWINGS SHALL HAVE SAME MEANING AND INTENT AS IF THEY WERE INCLUDED WITH PLANS REFERRED TO IN CONTRACT DOCUMENTS

- A. SUBSURFACE CONDITIONS PROMPTLY NOTIFY THE CONSULTANT IN WRITING IF THE SUB-SURFACE CONDITIONS AT THE PROJECT SITE DIFFER SUBSTANTIALLY FROM THOSE INDICATED IN THE CONTRACT DOCUMENTS OR SOIL REPORTS OR REPRESENTED TO THE CONTRACTOR BEFORE SUBMISSION OF TENDER.
- AFTER INVESTIGATION, SHOULD THE CONSULTANT AGREE THAT CONDITIONS DO DIFFER SUBSTANTIALLY, APPROPRIATE INSTRUCTIONS FOR CHANGES IN THE WORK WILL BE ISSUED.

B. RELICS AND ANTIQUITIES

- RELICS AND ANTIQUITIES AND ITEMS OF HISTORICAL OR SCIENTIFIC INTEREST SUCH AS CORNERSTONES AND CONTENTS, COMMEMORATIVE PLAQUES, INSCRIBED TABLETS, AND SIMILAR OBJECTS FOUND ON SITE OR IN BUILDINGS TO BE DEMOLISHED, SHALL REMAIN PROPERTY OF THE OWNER. PROTECT SUCH ARTICLES AND REQUEST DIRECTIVES FROM CONSULTANT.
- GIVE IMMEDIATE NOTICE TO CONSULTANT IF EVIDENCE OF ARCHEOLOGICAL FINDS ARE ENCOUNTERED DURING CONSTRUCTION, AND AWAIT HIS WRITTEN INSTRUCTIONS BEFORE PROCEEDING WITH WORK IN THIS AREA.

14. COORDINATION (SEE ALSO SECTION 01040)

- A. CONTRACTOR IS REQUIRED TO PROVIDE FULL COOPERATION AND ASSISTANCE TO ALL SUB-TRADES, IN THE LAYING OUT OF WORK.
- B. CONTRACTOR TO COORDINATE THE WORK OF ALL TRADES WITH EFFICIENT AND CONTINUOUS SUPERVISION.
- 15. ENVIRONMENT POLLUTION CONTROL
- A. THE CONTRACTOR SHALL: COMPLY WITH "THE PUBLIC HEALTH ACT" AND AMENDMENTS THERETO AND THE "PROVINCIAL BOARD OF HEALTH REGULATIONS" PUBLISHED UNDER THE AUTHORITY OF "THE PUBLIC HEALTH ACT", IN RESPECT TO POLLUTION CONTROL.
- B. THE FOLLOWING SHALL BE STRICTLY ENFORCED:

POLLUTION CONTROL FACILITIES.

- KEEP BUILDING SITE CLEAN AND FREE OF UNSIGHTLY AND/OR UNSAFE COLLECTION OF WASTE MATERIALS AND DEBRIS.
- PROVIDE FOR COLLECTION AND TEMPORARY STORAGE OF WASTE MATERIALS AND DEBRIS, IN METAL CONTAINERS WITH LIDS.
- DISPOSE OF WASTE MATERIALS AND DEBRIS TO THE LOCAL AUTHORITIES
- DO NOT ALLOW WASTE MATERIALS AND DEBRIS TO REACH AND CONTAMINATE ADJACENT PROPERTIES OR SPACE NOT BEING MODERNIZED AT THAT TIME WITHIN
- DO NOT BURN WASTE MATERIALS AND DEBRIS ON THE JOBSITE. • DO NOT THROW WASTE MATERIALS AND DEBRIS INTO BROOKS, STREAMS, RIVERS,

PONDS OR LAKES 16. OVERLOADING

- A. DO NOT LOAD OR PERMIT TO BE LOADED ANY PART OF THE WORK WITH A WEIGHT THAT WILL ENDANGER ITS SAFETY.
- B. SHOULD ANY ACCIDENT OCCUR BY VIOLATION OF THESE REQUIREMENTS. THE CONTRACTOR WILL BE HELD RESPONSIBLE AND LIABLE.

17. CLEANING OF STREETS

- A. TAKE PRECAUTION TO PREVENT THE DEPOSITING OF MUD ON AN ROADWAYS LEADING FROM THE SITE. ANY MUD OR DEBRIS DEPOSITED SHALL BE CLEANED UP IMMEDIATELY. NEGLECT OF THIS REQUIREMENT WILL CAUSE THE OWNER TO HAVE THE NECESSARY CLEAN-UP WORK CARRIED OUT AND CHARGE ALL COSTS TO THE CONTRACTOR.
- B. THE ABOVE REQUIREMENT ALSO APPLIES TO ROADWAYS OR PAVE AREAS ON SITE.

18. PUBLICITY

WILL NOT BE PERMITTED.

- A. ALL PUBLICITY RELATING TO THIS PROJECT IS SUBJECT TO THE APPROVAL OF THE
- B. NO MENTION OF THE PROJECT IN ADVERTISING OR ARTICLES IN ANY PUBLICATION WILL
- BE PERMITTED UNLESS APPROVED BY THE OWNER.

C. PUBLICITY OR ADVERTISING IMPLYING ENDORSEMENT OF A PRODUCT BY THE OWNER

- PRESERVATION OF PUBLIC HEALTH AND TO CONSTRUCTION SAFETY.
- B. CONTRACTOR SHALL OBTAIN AND PAY FOR LICENSES, CERTIFICATES AND APPROVALS

SECTION 01040 COORDINATION OF WORK

- A. COORDINATE ALL CONSTRUCTION ACTIVITIES AS REQUIRED TO ENSURE EFFICIENT AND
- ORDERLY INSTALLATION OF EACH PART OF THE WORK. B. WHERE INSTALLATION OF ONE PART OF THE WORK IS DEPENDENT ON INSTALLATION OF OTHER COMPONENTS, EITHER BEFORE OR AFTER ITS OWN INSTALLATION, SCHEDULE AND COORDINATE CONSTRUCTION ACTIVITIES IN THE SEQUENCE REQUIRED TO OBTAIN
- C. WHERE AVAILABILITY OF SPACE IS LIMITED, COORDINATE INSTALLATION OF DIFFERENT COMPONENTS TO ASSURE MAXIMUM ACCESSIBILITY FOR REQUIRED MAINTENANCE, SERVICE AND REPAIR.
- D. MAKE ADEQUATE PROVISIONS TO ACCOMMODATE ITEMS SCHEDULED FOR LATER INSTALLATION UNDER SEPARATE CONTRACT OR BY OWNER'S OWN FORCES.

2. ADMINISTRATIVE PROCEDURES

THE BEST RESULTS

GENERAL COORDINATION

- A. COORDINATE SCHEDULING AND TIMING OF REQUIRED ADMINISTRATIVE PROCEDURES WITH OTHER CONSTRUCTION ACTIVITIES TO AVOID CONFLICTS AND ENSURE ORDERLY PROGRESS OF THE WORK. SUCH ADMINISTRATIVE ACTIVITIES SHALL INCLUDE, BUT NOT
- BE LIMITED TO. THE FOLLOWING PREPARATION OF SCHEDULES INSTALLATION AND REMOVAL OF TEMPORARY FACILITIES.
- DELIVERY AND PROCESSING OF SUBMITTALS. PROGRESS MEETINGS

CONTRACT ACCEPTANCE PROCEDURES.

3. GENERAL INSTALLATION PROVISIONS

- A. REQUIRE THE INSTALLER OF EACH MAJOR COMPONENT TO INSPECT BOTH THE SUBSTRATE AND CONDITIONS UNDER WHICH WORK IS TO BE PERFORMED. DO NOT PROCEED UNTIL UNSATISFACTORY CONDITIONS HAVE BEEN CORRECTED IN AN ACCEPTABLE MANNER.
- B. COMPLY WITH THE MANUFACTURER'S INSTALLATION INSTRUCTIONS AND RECOMMENDATIONS, TO THE EXTENT THAT THOSE INSTRUCTIONS AND RECOMMENDATIONS ARE MORE EXPLICIT OR STRINGENT THAN REQUIREMENTS CONTAINED IN CONTRACT DOCUMENTS.
- C. INSPECT MATERIALS IMMEDIATELY UPON DELIVERY AND AGAIN PRIOR TO INSTALLATION. REJECT DAMAGED AND DEFECTIVE ITEMS.
- D. PROVIDE ATTACHMENT AND CONNECTION DEVICES AND METHODS NECESSARY FOR SECURING WORK. SECURE WORK TRUE TO LINE AND LEVEL. ALLOW FOR EXPANSION
- E. PROVIDE UNIFORM JOINT WIDTHS IN EXPOSED WORK. ARRANGE JOINTS IN EXPOSED WORK TO OBTAIN THE BEST VISUAL EFFECT. REFER QUESTIONABLE CHOICES TO CONSULTANT FOR FINAL DECISION.
- F. INSTALL EACH COMPONENT DURING WEATHER CONDITIONS AND PROJECT STATUS THAT WILL ENSURE THE BEST POSSIBLE RESULTS. ISOLATE EACH PART OF THE COMPLETED CONSTRUCTION FROM INCOMPATIBLE MATERIAL AS NECESSARY TO PREVENT DETERIORATION.
- G. COORDINATE TEMPORARY ENCLOSURES WITH REQUIRED INSPECTIONS AND TESTS, TO MINIMIZE THE NECESSITY OF UNCOVERING COMPLETED CONSTRUCTION FOR THAT
- H. WHERE MOUNTING HEIGHTS ARE NOT INDICATED, INSTALL INDIVIDUAL COMPONENTS AT STANDARD MOUNTING HEIGHTS RECOGNIZED WITHIN THE INDUSTRY FOR THE PARTICULAR APPLICATION INDICATED. REFER QUESTIONABLE MOUNTING HEIGHT DECISIONS TO THE CONSULTANT FOR FINAL DECISION.
- SUPERVISE CONSTRUCTION ACTIVITIES TO ENSURE THAT NO PART OF THE WORK, COMPLETED OR IN PROGRESS, IS SUBJECT TO HARMFUL, DANGEROUS OR OTHERWISE DELETERIOUS EXPOSURE DURING THE CONSTRUCTION PERIOD.

SECTION 01060 REGULATORY REQUIREMENTS

A. REGULATORY REQUIREMENTS MEANS LAWS, ORDINANCES, RULES, REGULATIONS, ORDERS, CODES AND OTHER LEGALLY ENFORCEABLE REQUIREMENTS IN EFFECT AT THE PLACE OF WORK AND APPLICABLE TO THE PERFORMANCE OF THE WORK.

- A. EXCEPT AS OTHERWISE INDICATED IN CONTRACT DOCUMENTS, CONTRACTOR SHALL: COMPLY WITH REGULATORY REQUIREMENTS AND PAY ALL FEES ASSOCIATED THEREWITH WHICH ARE IN FORCE AND LAWFULLY
- PAYABLE AT DATE OF TENDER CLOSING. B. THE OWNER SHALL OBTAIN PERMANENT EASEMENTS AND RIGHTS OF SERVITUDE

WHICH MAY BE REQUIRED FOR PERFORMANCE OF THE WORK.

- 3 CONTRACT DOCUMENTS A. CONTRACTOR SHALL NOT BE RESPONSIBLE FOR VERIFYING THAT CONTRACT DOCUMENT COMPLY WITH REGULATORY REQUIREMENTS. IF CONTRACT DOCUMENTS ARE AT VARIANCE THEREWITH, OR CHANGES WHICH REQUIRE MODIFICATION TO CONTRACT DOCUMENTS ARE MADE TO REGULATORY REQUIREMENTS, BY AUTHORITIES HAVING JURISDICTION, SUBSEQUENT TO DATE OF TENDER CLOSING. CONTRACTOR SHALL NOTIFY CONSULTANT IN WRITING, REQUESTING DIRECTION, IMMEDIATELY AS SUCH VARIANCE OR CHANGE BECOMES KNOWN TO HIM. CONSULTANT MAY MAKE CHANGES REQUIRED TO CONTRACT DOCUMENTS. AND ANY RESULTING CHANGE IN CONTRACT PRICE OR CONTRACT TIME WILL BE MADE IN ACCORDANCE WITH THE GENERAL CONDITIONS OF CONTRACT.
- B. IF CONTRACTOR FAILS TO NOTIFY CONSULTANT IN WRITING AND OBTAIN CONSULTANT'S DIRECTION AS REQUIRED IN PARAGRAPH 3.1 AND PERFORMS WORK KNOWING IT TO BE CONTRARY TO REGULATORY REQUIREMENTS, CONTRACTOR SHALL BE RESPONSIBLE FOR AND SHALL CORRECT VIOLATIONS THEREOF AND SHALL BEAR COSTS EXPENSES. AND DAMAGES ATTRIBUTABLE TO HIS FAILURE TO COMPLY WITH PROVISIONS OF SUCH

REGULATORY REQUIREMENTS. 4. PROVINCIAL BUILDING CODE

A. CONFORM TO AND PERFORM WORK IN ACCORDANCE WITH THE PROVINCIAL BUILDING

CODE, EXCEPT AS OTHERWISE INDICATED IN CONTRACT DOCUMENTS. PERMITS

- A. DEVELOPMENT PERMIT:
- OWNER SHALL APPLY FOR, PAY FOR AND OBTAIN DEVELOPMENT PERMIT.

A CONSPICUOUS LOCATION AT THE WORK SITE.

 CONTRACTOR SHALL APPLY FOR, OBTAIN AND PAY FOR BUILDING PERMIT AND OTHER PERMITS REQUIRED FOR THE WORK AND ITS VARIOUS PARTS. CONTRACTOR SHALL DISPLAY THE BUILDING PERMIT AND SUCH OTHER PERMITS IN

6. NOTICES, LICENSES AND CERTIFICATES

- A. CONTRACTOR SHALL GIVE REQUIRED NOTICES WHICH RELATE TO THE WORK, TO THE
- REQUIRED BY AUTHORITIES HAVING JURISDICTION AND THE CONTRACT DOCUMENTS.

SECTION 01310 SUBMITTALS

RESPONSIBLE PERSON.

CHECKING BY THE CONSULTANT.

SHOP DRAWINGS

- A. THE TERM "SHOP DRAWINGS" MEANS DRAWINGS, DIAGRAMS, ILLUSTRATIONS, SCHEDULES, PERFORMANCE CHARTS, BROCHURES AND OTHER DATA WHICH ARE TO BE PROVIDED BY THE CONTRACTOR TO ILLUSTRATE DETAILS OF A PORTION OF THE
- B. THE CONTRACTOR SHALL ARRANGE FOR THE PREPARATION OF CLEARLY IDENTIFIED SHOP DRAWINGS AS CALLED FOR BY THE CONTRACT DOCUMENTS AND FOR SUCH OTHER ITEMS AS THE CONSULTANT MAY REASONABLY REQUEST.
- C. SHOP DRAWINGS SHALL BE PREPARED IN ACCORDANCE WITH THE MANUAL ON METRIC BUILDING DRAWINGS PRACTICE PUBLISHED BY THE NATIONAL RESEARCH COUNCIL OF CANADA. CONFORMANCE WITH SECTION 4.1 TO 4.9 OF THE MANUAL IS NOT
- D. PRIOR TO SUBMISSION TO THE CONSULTANT. THE CONTRACTOR SHALL REVIEW ALL SHOP DRAWINGS. BY THIS REVIEW, THE CONTRACTOR CERTIFIES THAT HE HAS DETERMINED AND VERIFIED ALL FIELD MEASUREMENTS, FIELD CONSTRUCTION CRITERIA, MATERIALS, CATALOGUE NUMBERS AND SIMILAR DATA, AND CERTIFIES THAT HE HAS CHECKED AND COORDINATED EACH SHOP DRAWING WITH THE REQUIREMENTS OF THE WORK AND OF THE CONTRACT DOCUMENTS. THE CONTRACTOR'S REVIEW OF EACH SHOP DRAWING SHALL BE INDICATED BY STAMP, DATE AND SIGNATURE OF A
- E. NOT LESS THAN SIX (6) COPIES OF SHOP DRAWINGS SHALL BE SUBMITTED THROUGH THE CONTRACTOR TO THE CONSULTANT. IN ADDITION, THE CONTRACTOR, IF HE DEEMS NECESSARY. SHALL ARRANGE WITH HIS SUB-CONTRACTORS FOR ANY ADDITIONAL COPIES OF SHOP DRAWINGS THAT HE (THE CONTRACTOR) SHALL REQUIRE. THE SHOP DRAWINGS, WHEN SUBMITTED TO THE CONSULTANT, SHALL BEAR THE DATE STAMP OF, AND BE CHECKED BY, THE CONTRACTOR.
- F. WHEN SUBMITTING THE SHOP DRAWINGS THE CONTRACTOR SHALL NOTIFY THE CONSULTANT IN WRITING, ON THE SHOP DRAWING, OF ANY CHANGES THAT HE HAS MADE, FROM THAT WHICH HAS BEEN CALLED FOR IN THE DRAWINGS AND SPECIFICATIONS. FAILURE OF THE CONTRACTOR TO CHECK OR HAVE CORRECTED OR INDICATED ANY CHANGE AND VARIATION. IN SUBMITTING SHOP DRAWINGS. WILL RESULT IN THEIR RETURN TO THE CONTRACTOR WITHOUT CONSIDERATION OR
- G. IF THE SHOP DRAWINGS ARE REJECTED BY THE CONSULTANT HE WILL RETURN ONE (1) COPY TO THE CONTRACTOR, AND RETAIN ONE (1) COPY. ALL OTHER COPIES WILL BE
- H. THE CONTRACTOR SHALL RE-SUBMIT NOT LESS THAN FOUR (4). COPIES PLUS ANY ADDITIONAL COPIES, AS BEFORE DESCRIBED, OF THE REVISED SHOP DRAWINGS.

APPROVED SHOP DRAWINGS TO ALL PARTIES CONCERNED.

- AFTER REVIEW, THE CONSULTANT WILL RETAIN TWO (2) COPIES AND RETURN THE REMAINING COPIES TO THE CONTRACTOR, WHO SHALL THEN DISTRIBUTE THE
- J. THE CONSULTANT'S REVIEW OF SUCH DRAWINGS OR OF THE REVISED DRAWINGS SHALL NOT RELIEVE THE CONTRACTOR FROM RESPONSIBILITY FOR ERROR OR FOR CHANGES MADE FROM THE CONSULTANT'S DRAWINGS OR SPECIFICATIONS.
- K. THE CONTRACTOR SHALL SUBMIT SHOP DRAWINGS TO THE CONSULTANT FOR HIS REVIEW WITH REASONABLE PROMPTNESS. THE CONSULTANT SHALL HAVE A MINIMUM OF FIVE WORKING DAYS EXCLUDING SATURDAY AND SUNDAY FOR SUCH REVIEW. SHOP DRAWINGS SHALL BE SUBMITTED IN THE FORM OF REPRODUCIBLE TRANSPARENCIES OR PRINTS AS THE CONSULTANT MAY DIRECT. AT THE TIME OF SUBMISSION THE CONTRACTOR SHALL NOTIFY THE CONSULTANT IN WRITING OF ANY DEVIATIONS IN THE SHOP DRAWINGS FROM THE REQUIREMENTS OF THE CONTRACT DOCUMENTS.

- A. THE CONTRACTOR SHALL SUBMIT, FOR THE CONSULTANT'S REVIEW, SUCH STANDARD MANUFACTURERS' SAMPLES AS THE CONSULTANT MAY REASONABLY REQUIRE.
- SAMPLES SHALL BE LABELED AS TO ORIGIN AND INTENDED USE IN THE WORK. B. THE CONTRACTOR SHALL PROVIDE SAMPLES OF SPECIAL MATERIAL, ASSEMBLIES, OR

3. OPERATING/MAINTENANCE MANUALS

COMPONENTS WHEN SO SPECIFIED.

- A. PRIOR TO ISSUANCE OF CERTIFICATES OF SUBSTANTIAL COMPLETION, THE CONTRACTOR SHALL SUBMIT THREE COMPLETE SETS OF OPERATING MANUALS AND MAINTENANCE INSTRUCTIONS AS CALLED FOR IN THE CONTRACT DOCUMENTS, MADE
- BIND DATA IN VINYL HARD COVER, VARIABLE CAPACITY, EXPANDING BINDER WITH
- FNCI OSE TITLE SHEET. LABELED "OPERATING AND MAINTENANCE DATA MANUAL PROJECT NAME, DATE AND LIST OF CONTENTS.

ORGANIZE CONTENTS INTO APPLICABLE SECTIONS OF WORK TO PARALLEL PROJECT

SPECIFICATIONS SECTION BREAKDOWN. IDENTIFY EACH SECTION WITH TABS OF

FULL METAL HINGE AND SLIDE LOCK MECHANISM FOR 8 1/2" X 11" SIZE PAPER.

- LAMINATED MYLAR PLASTIC. SEE MECHANICAL SPECS FOR COLOURED TAB
- MAINTENANCE INSTRUCTIONS FOR FINISHED SURFACES AND MATERIALS. COPY OF HARDWARE AND PAINT SCHEDULES.

B. INCLUDE THE FOLLOWING INFORMATION PLUS DATA SPECIFIED.

- NAMES, ADDRESSES AND PHONE NUMBERS OF SUBCONTRACTORS AND SUPPLIERS.
- GUARANTEES, WARRANTIES AND BOND SHOWING: NAME AND ADDRESS OF THE PROJECT. WARRANTY/GUARANTEE/BOND COMMENCEMENT DATE AND DURATION.
- CLEAR INDICATION OF WHAT IS BEING GUARANTEED AND WHAT REMEDIAL ACTION WILL BE TAKEN UNDER GUARANTEE SIGNATURE AND SEAL OF CONTRACTOR.
- ADDITIONAL MATERIAL/EQUIPMENT USED IN PROJECT LISTED UNDER VARIOUS SECTIONS SHOWING NAME OF MANUFACTURER AND SOURCE OF SUPPLY.
- C. NEATLY TYPE LISTS AND NOTES. USE CLEAR DRAWINGS, DIAGRAMS OR MANUFACTURERS' LITERATURE. D. INCLUDE ONE COMPLETE SET OF REVIEWED SHOP DRAWINGS (BOUND SEPARATELY)

INDICATING CORRECTIONS AND CHANGES MADE DURING FABRICATION AND

- 4. MAINTENANCE MATERIALS A. WHERE SUPPLY OF MAINTENANCE MATERIALS ARE SPECIFIED, DELIVER TO
- CONSULTANT IN ACCORDANCE WITH FOLLOWING: • USE UNBROKEN CARTONS, OR IF NOT SUPPLIED IN CARTONS, THEY SHALL BE
- SECURELY PACKAGED. · CLEARLY MARK AS TO CONTENT.

B. THE CONSULTANT WILL SUPPLY A FRESH SET OF PRINTS FOR THIS PURPOSE.

5. PROJECT RECORD DRAWINGS

6. PROGRESS REPORTS

A. PRIOR TO ISSUANCE OF CERTIFICATE OF SUBSTANTIAL COMPLETION, THE CONTRACTOR SHALL SUPPLY TO THE CONSULTANT A SET OF PRINTS INDICATING ANY CHANGES FROM THE CONTRACT DRAWINGS.

IF APPLICABLE, IDENTIFY COLOUR, ROOM NUMBER OR AREA WHERE MATERIAL

A. THE GENERAL CONTRACTOR SHALL KEEP A PERMANENT, WRITTEN RECORD ON THE SITE OF THE PROGRESS OF THE WORK. THIS RECORD SHALL BE OPEN TO THE SITE INSPECTIONS OF THE OWNER, AND COPIES SHALL BE FURNISHED TO THE OWNER UPON REQUEST. THIS RECORD SHALL SHOW DATES OF COMMENCEMENT AND COMPLETION

OF ALL TRADES AND PARTS OF THE WORK. IT SHALL INCLUDE PARTICULARS

AS THE NUMBER OF EMPLOYEES OF THE VARIOUS TRADES INVOLVED.

REGARDING DAILY WEATHER CONDITIONS VARIOUS PARTS OF THE WORK (SUCH AS

EXCAVATION, ERECTION AND REMOVAL OF FORMS, PLACING OF CONCRETE), AS WELL

SECTION 01400 QUALITY CONTROL

1. INSPECTION OF WORK

- A. THE CONSULTANT SHALL HAVE ACCESS TO THE WORK FOR INSPECTION PURPOSES. THE CONTRACTOR SHALL PROVIDE REASONABLE FACILITIES FOR SUCH ACCESS.
- B. IF SPECIAL TESTS, INSPECTIONS OR APPROVAL ARE REQUIRED BY THE CONTRACT DOCUMENTS, THE CONSULTANT'S INSTRUCTIONS, OR THE LAWS OR ORDINANCES OF THE PLACE OF BUILDING. THE CONTRACTOR SHALL GIVE THE CONSULTANT TIMELY NOTICE REQUESTING INSPECTION. THE CONTRACTOR SHALL ARRANGE INSPECTIONS BY OTHER AUTHORITIES HAVING JURISDICTION AND SHALL NOTIFY THE CONSULTANT OF
- C. IF THE CONTRACTOR COVERS OR PERMITS TO BE COVERED ANY WORK THAT IS SUBJECT TO INSPECTION OR BEFORE ANY SPECIAL TESTS AND APPROVALS ARE COMPLETED WITHOUT THE APPROVAL OF THE CONSULTANT, THE CONTRACTOR SHALL UNCOVER THE WORK, HAVE THE INSPECTIONS SATISFACTORILY COMPLETED AND MAKE GOOD THE WORK AT HIS OWN EXPENSE
- D. EXAMINATION OF ANY QUESTIONED WORK MAY BE ORDERED BY THE CONSULTANT. IF SUCH WORK IS FOUND NOT IN ACCORDANCE WITH THE CONTRACT. THE CONTRACTOR
- E. THE CONTRACTOR SHALL PROMPTLY FURNISH TO THE CONSULTANT, ALL CERTIFICATES AND/OR COPIES OF ALL INSPECTION REPORTS OF TESTS TO THE WORK.

REJECTED WORK

THE CONTRACT DOCUMENTS AT THE CONTRACTOR'S EXPENSE.

SHALL REMEDY SAME AND PAY ALL COSTS

- A. DEFECTIVE WORK, WHETHER THE RESULT OF POOR WORKMANSHIP, USE OF DEFECTIVE MATERIALS OR DAMAGE THROUGH CARELESSNESS OR OTHER ACT OF THE CONTRACTOR, AND WHETHER INCORPORATED IN THE WORK OR NOT, WHICH HAS BEEN REJECTED BY THE CONSULTANT AS FAILING TO CONFORM TO THE CONTRACT DOCUMENTS SHALL BE REMOVED PROMPTLY FROM THE PREMISES BY THE CONTRACTOR AND REPLACE AND/OR RE-EXECUTED PROMPTLY IN ACCORDANCE WITH
- B. IF IN THE OPINION OF THE CONSULTANT IT IS NOT EXPEDIENT TO CORRECT DEFECTIVE WORK OR WORK NOT DONE IN ACCORDANCE WITH THE CONTRACT DOCUMENTS. THE CONSULTANT MAY DEDUCT FROM THE CONTRACT PRICE THE DIFFERENCE IN VALUE BETWEEN THE WORK AS DONE AND THAT CALLED FOR BY THE CONTRACT, THE AMOUNT OF WHICH SHALL BE DETERMINED IN THE FIRST INSTANCE BY THE CONSULTANT.

3. TESTS AND MIX DESIGNS

- A. THE CONTRACTOR SHALL FURNISH TO THE CONSULTANT, TEST RESULTS AND MIX
- DESIGNS AS MAY BE REQUESTED. B. THE COST OF TESTS AND MIX DESIGNS BEYOND THOSE CALLED FOR IN THE CONTRACT DOCUMENTS OR BEYOND THOSE REQUIRED BY LAWS, ORDINANCES, RULES AND REGULATIONS RELATING TO THE WORK AND THE PRESERVATION OF PUBLIC HEALTH,

MAY BE AUTHORIZED BY THE OWNER AS AN ADDITION TO THE CONTRACT PRICE.

- A. WITHIN THE TEXT OF THESE SPECIFICATIONS, REFERENCE MAY BE MADE TO THE
- FOLLOWING STANDARDS: ANSI - AMERICAN NATIONAL STANDARDS INSTITUTE
- ASTM AMERICAN SOCIETY FOR TESTING AND MATERIALS CGSB - CANADIAN GENERAL STANDARDS BOARD
- CSA CANADIAN STANDARDS ASSOCIATION CAN2 - NATIONAL STANDARD OF CANADA (PUBLISHED BY CGSB) CAN3 - NATIONAL STANDARD OF CANADA (PUBLISHED BY CSA)

FM - FACTORY MUTUAL ENGINEERING CORPORATION

• ULC - UNDERWRITERS LABORATORIES OF CANADA B. THE TESTING OF MATERIALS MAY BE REQUESTED BY THE CONSULTANT, TO PROVE

C. THE REFERENCED STANDARD AND ANY AMENDMENTS IN FORCE ON THE DAY OF

CONFORMANCE WITH STANDARDS, AND SHALL BE PAID FOR BY THE CONTRACTOR.

RECEIPT OF TENDERS SHALL BE APPLICABLE TO THE WORK DURING THE DURATION OF

INSTRUCTIONS FOR MATERIALS AND INSTALLATION METHOD TO BE USED. B. NOTIFY CONSULTANT IN WRITING OF ANY CONFLICT BETWEEN THESE SPECIFICATIONS AND MANUFACTURER'S INSTRUCTIONS, SO THAT CONSULTANT CAN DESIGNATE WHICH

GENERAL

SPECIFICATIONS IS TO BE FOLLOWED.

SPACERS FOR SECURING EXTERIOR WORK

SECTION 01600 PRODUCTS AND WORKMANSHIP

2. MANUFACTURER'S INSTRUCTIONS

A. USE NEW PRODUCTS UNLESS OTHERWISE SPECIFIED.

3. SPACE ANCHORS WITHIN LIMITS OF LOAD BEARING OR SHEAR CAPACITY AND ENSURE THAT THEY PROVIDE POSITIVE PERMANENT ANCHORAGE. WOOD PLUGS NOT

A. PROVIDE METAL FASTENINGS AND ACCESSORIES IN SAME TEXTURE, COLOUR AND

FINISH AS BASE METAL IN WHICH THEY OCCUR. PREVENT ELECTROLYTIC ACTION

BETWEEN DISSIMILAR METALS. USE NON-CORROSIVE FASTENERS, ANCHORS AND

A. UNLESS OTHERWISE SPECIFIED, COMPLY WITH MANUFACTURER'S LATEST PRINTED

- C. KEEP EXPOSED FASTENINGS TO MINIMUM, SPACE EVENLY AND LAY OUT NEATLY. D. FASTENINGS WHICH CAUSE SPALLING OR CRACKING OF MATERIAL TO WHICH
- ANCHORAGE IS MADE ARE NOT ACCEPTABLE. E. OBTAIN CONSULTANT'S APPROVAL BEFORE USING EXPLOSIVE ACTUATED FASTENING

DEVICES. IF APPROVAL IS OBTAINED COMPLY WITH CSA Z166-1966.

- SUPERINTENDENCE A. THE CONTRACTOR SHALL EMPLOY A COMPETENT SUPERINTENDENT AND NECESSARY ASSISTANTS WHO SHALL BE IN ATTENDANCE AT THE WORK SITE AT ALL TIMES DURING
- B. THE SUPERINTENDENT SHALL BE SATISFACTORY TO THE CONSULTANT AND SHALL NOT BE CHANGED EXCEPT FOR GOOD REASON AND ONLY AFTER CONSULTATION WITH AN AGREEMENT FROM THE CONSULTANT. C. THE SUPERINTENDENT SHALL REPRESENT THE CONTRACTOR AT THE WORK SITE AND

TO THE CONTRACTOR IMPORTANT DIRECTIONS SHALL BE CONFIRMED TO THE

DIRECTIONS GIVEN TO HIM BY THE CONSULTANT SHALL BE HELD TO HAVE BEEN GIVEN

CONTRACTOR IN WRITING, OTHER DIRECTIONS WILL BE SO CONFIRMED IF REQUESTED.

THE PROGRESS OF THE WORK.

LABOUR AND MATERIALS A. UNLESS OTHERWISE STIPULATED ELSEWHERE IN THE CONTRACT DOCUMENTS, THE CONTRACTOR SHALL PROVIDE AND PAY FOR ALL LABOUR, MATERIALS, EQUIPMENT TOOLS, CONSTRUCTION EQUIPMENT AND MACHINERY, AND OTHER FACILITIES AND

SERVICES NECESSARY FOR THE PROPER PERFORMANCE OF THE WORK.

EQUIPMENT NOT SPECIFICALLY DETAILED IN THE SPECIFICATIONS SHALL BE OF A QUALITY BEST SUITED TO THE PURPOSE REQUIRED AND THEIR USE SUBJECT TO THE APPROVAL OF THE CONSULTANT. C. AT ALL TIMES, MAINTAIN GOOD ORDER AND DISCIPLINE AMONG EMPLOYEES ENGAGED

ON THE WORK. DO NOT EMPLOY ON THE WORK, ANY UNFIT PERSON OR ANY ONE NOT

B. ALL MATERIALS AND EQUIPMENT INCORPORATED IN THE WORK, SHALL BE NEW UNLESS

OTHERWISE SPECIFIED IN THE CONTRACT DOCUMENTS. ANY MATERIALS OR ITEMS OF

SKILLED IN THE TASK ASSIGNED TO HIM.

CUTTING AND REMEDIAL WORK

A. DO ALL CUTTING AND REMEDIAL WORK THAT MAY BE REQUIRED TO MAKE SEVERAL PARTS OF THE WORK COME TOGETHER PROPERLY.

B. COORDINATE AND SCHEDULE THE WORK TO ENSURE THAT THIS REQUIREMENT IS KEPT

C. CUTTING AND REMEDIAL WORK SHALL BE PERFORMED BY SPECIALISTS FAMILIAR WITH THE MATERIALS AFFECTED AND SHALL BE PERFORMED IN A MANNER TO NEITHER DAMAGE NOR ENDANGER ANY WORK.

D. PRIOR TO CUTTING OR CURING ANY PRECAST CONCRETE OR STEEL STRUCTURAL

MEMBER, REQUEST ON-SITE INSPECTION BY STRUCTURAL ENGINEER TO APPROVE

- DELIVERY AND STORAGE
- A. DELIVER, STORE AND MAINTAIN PACKED MATERIALS WITH MANUFACTURER'S SEALS AND LABELS INTACT.
- B. PREVENT DAMAGE, ADULTERATION AND SOILING OF MATERIALS DURING DELIVERY. HANDLING AND STORAGE. IMMEDIATELY REMOVE REJECTED MATERIALS FROM SITE.

DELAY COMPLETION OF CONTRACT, OR:

- C. STORE MATERIALS IN ACCORDANCE WITH SUPPLIERS INSTRUCTIONS. 8. SUBSTITUTIONS
- A. PROPOSALS FOR SUBSTITUTION PRIOR TO TENDERING AS PER INSTRUCTIONS TO B. PROPOSALS FOR SUBSTITUTION MAY BE SUBMITTED AFTER AWARD OF CONTRACT.
- ORIGINALLY SPECIFIED AND PROPOSED SUBSTITUTIONS C. PROPOSALS WILL BE CONSIDERED BY CONSULTANT IF: PRODUCTS SELECTED BY TENDERED FROM THOSE SPECIFIED, ARE NOT AVAILABLE.

DELIVERY DATE OF PRODUCTS SELECTED FROM THOSE SPECIFIED WOULD UNDULY

SUCH REQUESTS MUST INCLUDE STATEMENTS OF RESPECTIVE COSTS OF ITEMS

 ALTERNATIVE PRODUCTS TO THOSE SPECIFIED, WHICH ARE BROUGHT TO ATTENTION OF, AND CONSIDERED BY CONSULTANT AS EQUIVALENT TO THOSE SPECIFIED AND WILL RESULT IN CREDIT TO CONTRACT AMOUNT. D. SHOULD PROPOSED SUBSTITUTION BE ACCEPTED EITHER IN PART OR IN WHOLE.

ASSUME FULL RESPONSIBILITY AND COSTS WHEN SUBSTITUTION AFFECTS OTHER

WORK ON PROJECT. PAY FOR DRAWING CHANGES REQUIRED AS A RESULT OF E. ALL CREDIT ARISING FROM APPROVAL OF SUBSTITUTIONS WILL BE CREDITED TO

CONTRACT IN SUCH AMOUNTS AS MAY BE DETERMINED BY CONSULTANT AND

PERMITTED WITHOUT THE PRIOR WRITTEN APPROVAL OF CONSULTANT.

CONTRACT PRICE WILL BE ADJUSTED ACCORDINGLY. NO SUBSTITUTIONS WILL BE

A. ALL PRODUCTS SHALL BE NEW UNLESS OTHERWISE SPECIFIED IN THE CONTACT DOCUMENTS ANY PRODUCTS WHICH ARE NOT SPECIFIED SHALL BE OF A QUALITY


OF THE CONSULTANT.

10. RAINSCREEN TECHNOLOGY

MATERIALS

A. CONTRACTORS, TRADE CONTRACTORS, SUB-CONTRACTORS AND INSTALLERS SHALL ENSURE ALL EXTERIOR FINISHES, VENEERS AND FACADES ARE CONSTRUCTED OR INSTALLED UTILIZING A MINIMUM 10mm (1/2") RAINSCREEN DRAINAGE LAYER IN ACCORDANCE WITH NRC CNRC CONSTRUCTION TECHNOLOGY UPDATE NO. 34. RAINSCREEN DRAINAGE SYSTEM SPECIFICATIONS AND INSTALLATION PROCEDURES SHALL BE SUBMITTED TO THE CONSULTANT FOR REVIEW PRIOR TO INSTALLATION. THE CONSULTANT DOES NOT APPROVE, WARRANTEE OR GUARANTEE THE INSTALLATION OF ANY EXTERIOR FINISH OR BUILDING ENVELOPE COMPONENT THAT DOES NOT MAINTAIN RAINSCREEN TECHNOLOGY.

BEST SUITED TO THE PURPOSE REQUIRED AND THEIR USE SUBJECT TO THE APPROVAL

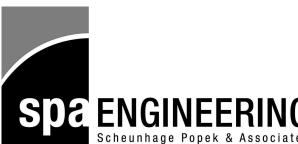

Z

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IN THE CASE OF A DISCREPANCY BETWEEN THE CONTRACT

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REVISION

2020.05.20

2020.06.02

CLEARHILLS COUNTY

CLEARHILLS FIREHALL

ISSUED FOR:

90% CLIENT REVIEW

TENDER


SITE DESCRIPTION: LOT 84 & 85, BLOCK 1, PLAN 07262595, CLEARDALE, CLEARHILLS COUNTY, AB

MC PROF. REVIEW: DRAWN BY: TECH. REVIEW: RM FINAL REVIEW:

DRAWING NUMBER

SPA PROJECT NUMBER:

EDGE OF EX. ASPHALT

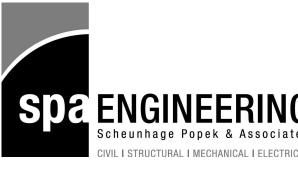



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2020.06.02

20-048

REVISION:

CLEARHILLS COUNTY

TENDER

CLEARHILLS FIREHALL


SITE DESCRIPTION: LOT 84 & 85, BLOCK 1, PLAN 07262595,

SITE PLAN

DRAWN BY: MC PROF. REVIEW: TECH. REVIEW: RM FINAL REVIEW:

CLEARDALE, CLEARHILLS COUNTY, AB

SPA PROJECT NUMBER: DRAWING NUMBER:

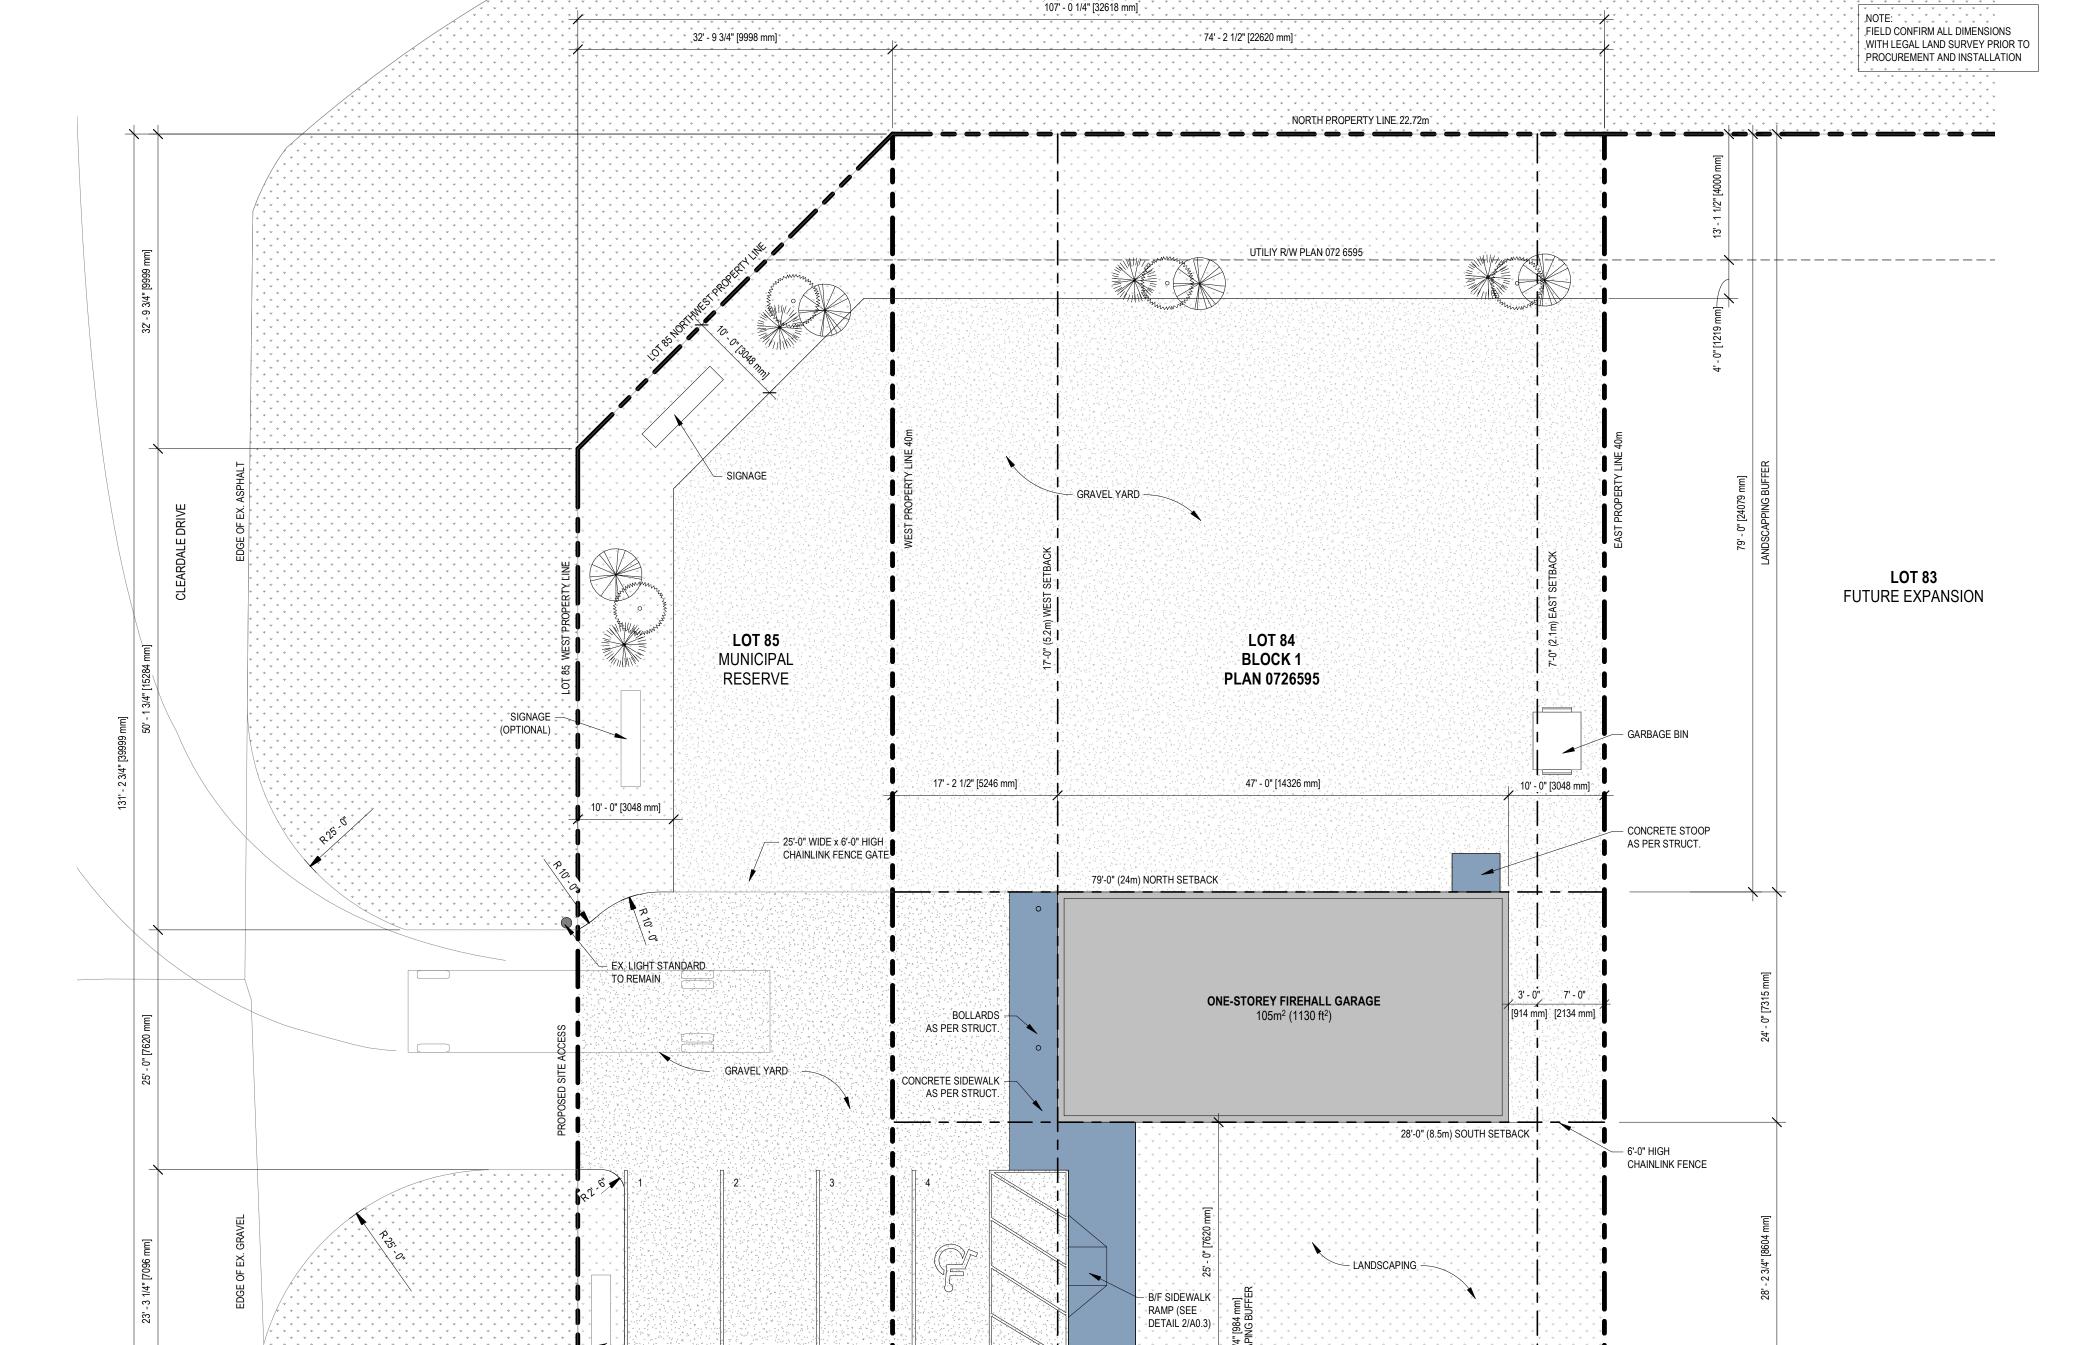




PERMIT SIGNAGE

(SEE DETAIL 1/A0.3)

FOR B/F STALL

18' - 4" [5589 mm]

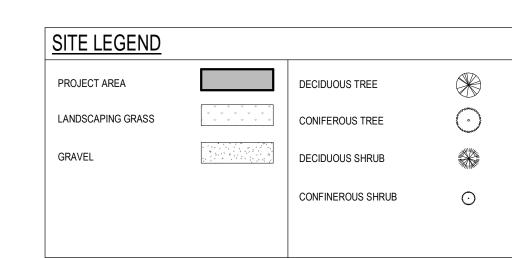

7' - 0" [2134 mm]

SITE INFORMATION

BUILDING AREA: 1130ft² (102 m²)

WEST SETBACK: 17'-0" (5.2m) REQ.

HANDICAPPED STALLS PROVIDED: 1 STALL

LANDSCAPING: AT THE DISCRETION OF THE DEV. AUTH.

SITE COVERAGE: 12%

LEGAL DESCRIPTION: LOT 84 & 85, BLOCK 1, PLAN 0726595

NORTH SETBACK: 79'-0" (24m) REQ. PROVIDED: 79'-0" (24m) SOUTH SETBACK: 28'-0" (8.5m) REQ. PROVIDED: 28'-0" (8.5m)


EAST SETBACK: 7'-0" (2.1m) REQ. PROVIDED: 10'-0" (3.0m)

MAX. BUILDING HEIGHT: AT THE DISCRETION OF THE DEV. AUTH.

PARKING STALLS REQUIRED: AT THE DISCRETION OF THE DEV. AUTH. PARKING STALLS PROVIDED: 3 STALLS

PROVIDED: 17'-0" (5.2m)

ZONING: HAMLET RESIDENTIAL DISTRICT 2 (HR-2) PERMITTED USE: PUBLIC USE - FIREHALL

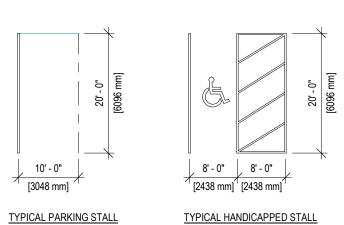

CONIFEROUS TREE PLANTING DETAIL

PRUNE ONLY DEAD, BROKEN,

OR DISEASED TREE LIMBS

RUBBER BLACK HOSE - 12mm

POSITIONED APPROX 3/5 HT.

— 3 STAKES PER TREE. ALL EXPOSED PORTIONS OF TREE STAKES FREE OF RUST SCALED AND PRIMED. TREE STAKES MIN. 2.1m LENGTH STUDDED HEAVYWEIGHT T-POSTS (7.5 POUNDS). TREE STAKE SET MIN. 300mm INTO UNDISTURBED SOIL.

100mm MIN. MULCH AS SPECIFIED OVER EXPOSED

BASE OF TREE.

'B' TOPSOIL

SPECIFICATIONS — SCARIFY WALL OF TREE WELL

ROOTBALL. TAPER MULCH TO

REESTABLISH ANY DAMAGED SEED/SOD, TO SPECIFICATIONS - ALUMINUM EDGER W/MULCH MIN. 25mm BELOW TOP EDGE - LIGHTLY COMPACTED CLASS

- FOLD 1/3 WIRE BASKET AND BURLAP FROM TOP OF ROOTBALL 50mm MAX. BELOW FINISHED GRADE. BURLAP TO BE TREATED NATURAL FIBER. ROOTBALL MIN. SIZE AS PER

- UNDISTURBED NATIVE SOIL

PRUNE ONLY DEAD, BROKEN,

- RUBBER BLACK HOSE - 12mm

POSITIONED APPROX 3/5 HT.

— GALVANIZED GUY WIRE No. 12 MIN.

STAKES FREE OF RUST SCALED

AND PRIMED. TREE STAKES MIN.

POUNDS). TREE STAKE SET MIN.

300mm INTO UNDISTURBED SOIL.

OR DISEASED TREE LIMBS

OR APPROVED EQUAL.

— 3 STAKES PER TREE. ALL

2.1m LENGTH STUDDED HEAVYWEIGHT T-POSTS (7.5

100mm MIN. MULCH AS

BASE OF TREE.

'B' TOPSOIL

SPECIFICATIONS

SPECIFIED OVER EXPOSED

ROOTBALL. TAPER MULCH TO

- REESTABLISH ANY DAMAGED

MIN. 25mm BELOW TOP EDGE - LIGHTLY COMPACTED CLASS

FOLD 1/3 WIRE BASKET AND BURLAP FROM TOP OF ROOTBALL 50mm MAX. BELOW FINISHED GRADE. BURLAP TO BE TREATED NATURAL FIBER. ROOTBALL MIN. SIZE AS PER

SCARIFY WALL OF TREE WELL

UNDISTURBED NATIVE SOIL

SEED/SOD, TO SPECIFICATIONS - ALUMINUM EDGER W/MULCH

FOR ALL TREES

GALVANIZED GUY WIRE No. 12 MIN.

OR APPROVED EQUAL.

FOR ALL TREES

ANGLE STAKES @ 2 DEGREES —

ANGLE STAKES @ 2 DEGREES —

LESS THAN 100mm CALIPER:

1. DIG ALL ROOT HOLES BY HAND WHEN CLOSER THAN 1.0m TO U.G. POWER,

2. POSITION TREE STAKES INTO DIRECTION OF

3. ALL TREE STAKES TO MAINTAIN MIN. 1.0m

LESS THAN 3m HEIGHT:

1. DIG ALL ROOT HOLES BY HAND WHEN CLOSER

2. POSITION TREE STAKES INTO DIRECTION OF

3. ALL TREE STAKES TO MAINTAIN MIN. 1.0m

CLEARANCE FROM ALL U.G. POWER,

PREVAILING WINDS

TELEPHONE AND GAS

THAN 1.0m TO U.G. POWER, TELEPHONE AND

DECIDUOUS TREE PLANTING DETAIL

CLEARANCE FROM ALL U.G. POWER,

TELEPHONE AND GAS

TELEPHONE AND GAS

12" = 1'-0"

PREVAILING WINDS

TYPICAL PARKING STALLS

SIGNAGE

4' - 10 1/4" [1478 mm]

LOT 85 SOUTH PROPERTY LINE

27' - 11 1/2" [8520 mm]

46' - 3 1/2" [14110 mm]

·(OPTIONAL)

SOUTH PROPERTY LINE 22.72m

48' - 10 1/2" [14897 mm]


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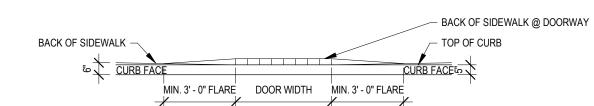
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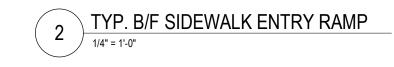



2" GALVANIZED POST, HILTI INTO CONC. SIDEWALK

BREAKAWAY FLANGE






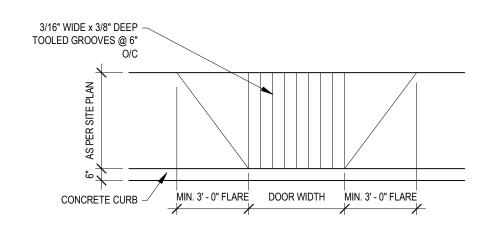

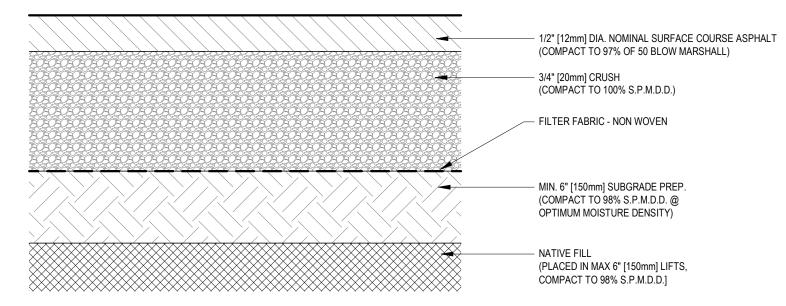

3 LIGHT DUTY ASPHALT STRUCTURE
NOT TO SCALE

ASPHALT & GRAVEL DEPTHS AS PER GEOTECHNICAL INVESTIGATION U.N.O.

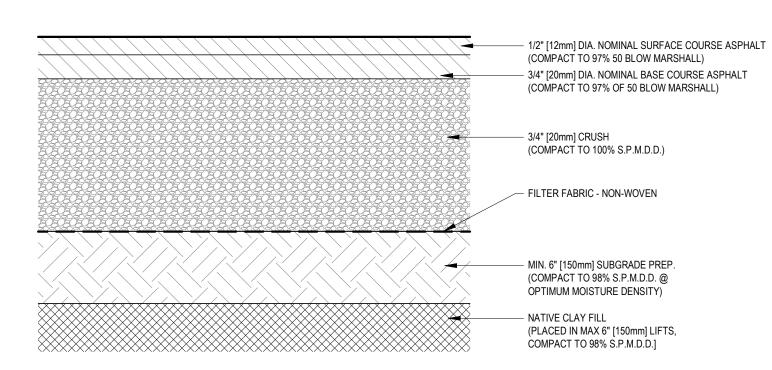

4 HEAVY DUTY ASPHALT STRUCTURE

NOTE:
• ASPHALT & GRAVEL DEPTHS AS PER GEOTECHNICAL INVESTIGATION U.N.O.

NOTES

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CLEARHILLS COUNTY

PROJECT:
CLEARHILLS FIREHALL


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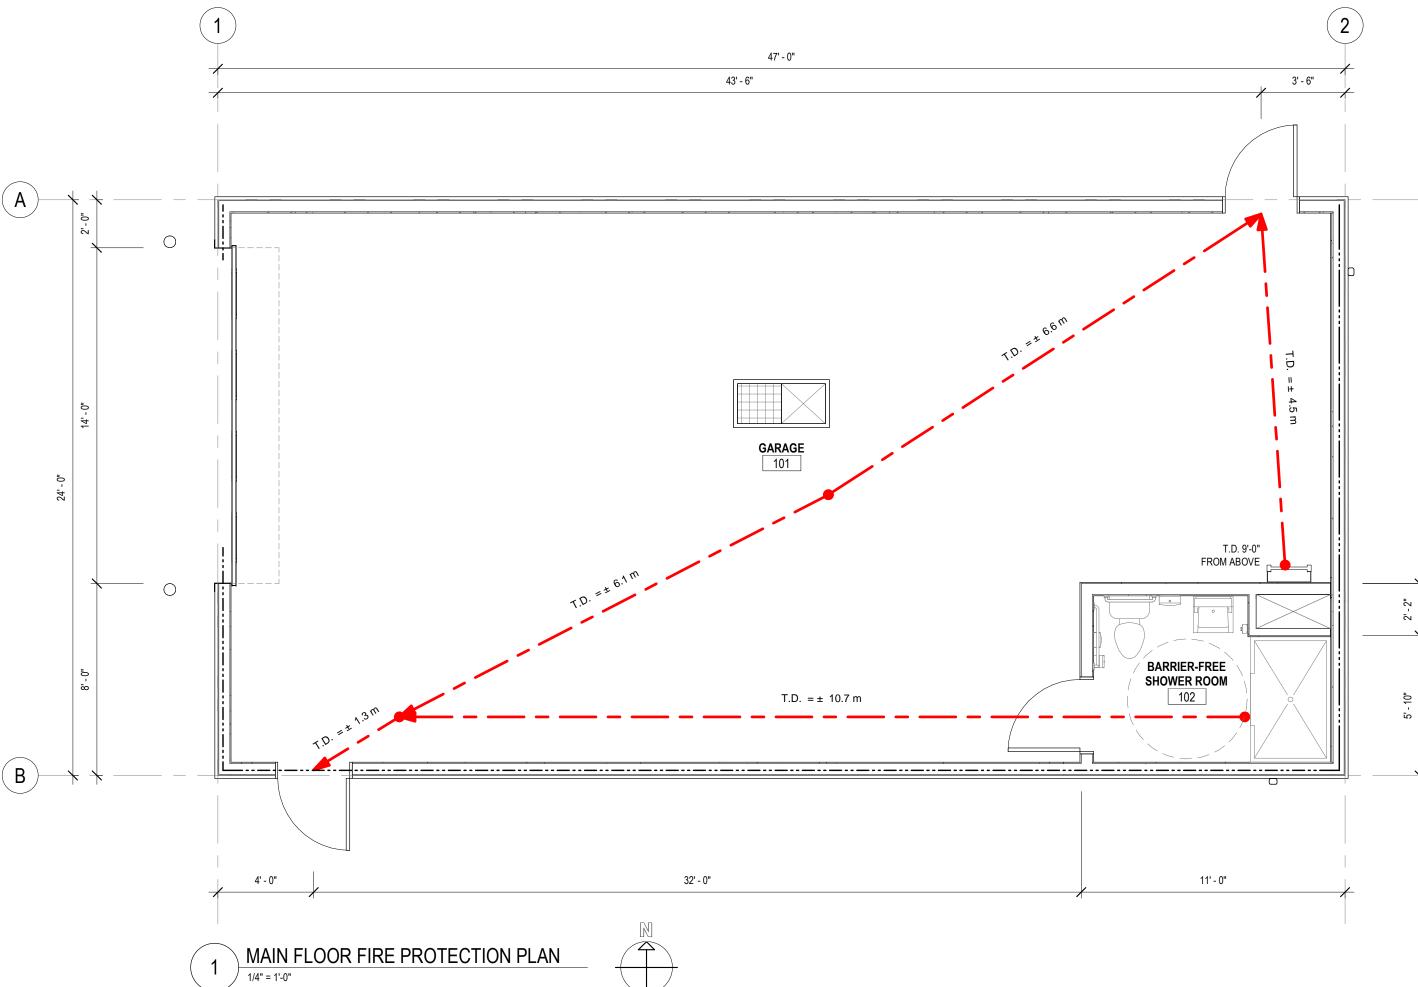
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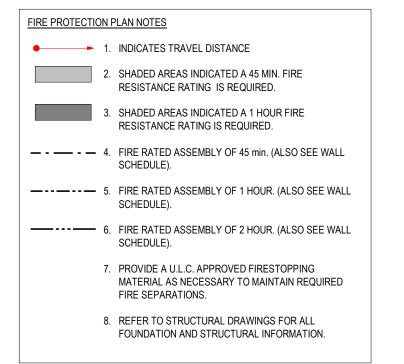
SITE DETAILS

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	SPA PROJECT NUMBER:				20-0
	TECH. REVIEW:	RM	FINAL REVIE	W:	
	DRAWN BY:	МС	PROF. REVIE	EW:	
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THE FOLLOWING ARE HIGHLIGHTED AREAS OF THE CURRENT PROVINICAL BUILDING CODE THAT RELATE TO PUBLIC BUILDING		EXPOSED BUILDING FACE:		NORTH WALL	SOUTH WALL	EAST WALL	WEST WALL
LOCATED IN CLEARHILLS COUNTY	,	MAX AREA (m²): (3.2.3.1)		74 m²	74 m ²	36 m ²	36 m ²
	DE REFERENCES ARE LISTED EDESIGNED TO THE CURRENT PROVINCIAL BUILDING CODE AND IT IS THE RESPONSIBILITY	LIMITING DISTANCE (m):		24m	8.5m	3.0m	5.2m
OF THE BUILDER TO ME AUTHORITES HAVING JI	ET AND/OR EXCEED THE REQUIREMENTS OF THE CURRENT BUILDING CODE AND THE JRISDICTION.	ALLOWABLE OPENINGS (%):		100%	50%	12%	39%
BUILDING ADDRESS:	LOT 84 & 85, BLOCK 1, PLAN 07262595	REQ. EXTERIOR WALL FIRE RESISTANCE	RATING:	N/A	1 HR	2 HR	1 HR
MAJOR OCCUPANCY:	GROUP F DIVISION 2 - MEDIUM HAZARD INDUSTRIAL - FIREHALL	FIRE WALL:	N/A				
BUILDING CLASSIFICATION:	PART 9 - MEDIUM HAZARD INDUSTRIAL	OCCUPANCY LOAD:	3 PERSC	DNS			
NUMBER OF STREETS FACING:	FACING TWO (2) STREETS [3.2.2.10]	OCCUPANCY SEPARATION:	N/A				
BUILDING AREA (ft²/m²):	1130ft² / 105m²	SUITE SEPARATION:	N/A				
BUILDING HEIGHT:	ONE (1) STOREY WITH MAX AREA FACING TWO (2) STREETS = 1250m ²	WATER CLOSETS REQUIRED:	1 REQUI	RED			
BUILDING CONSTRUCTION TYPE:	COMBUSTIBLE OR NON-COMBUSTIBLE CONSTRUCTION	FIRE SUPPRESSION SYSTEM:	NOT SPF	RINKLERED			
FLOOR ASSEMBLY REQ.:	N/A [9.10.8.1.]	FIRE ALARM SYSTEM:	NO				
MEZZANINE ASSEMBLY REQ.:	N/A [9.10.8.1.]	FURNACE ROOM:		IAVE A <i>FIRE SEI</i> IAN <u>1 HOUR</u> [3.6	PARATION W/ A F .2.1.(1)]	IRE RESISTANCI	<i>≣ RATING</i> NOT
ROOF ASSEMBLY REQ.:	N/A [9.10.8.1.]	SMOKE ALARM:	NO				
BEARING ASSEMBLY REQ.:	EXCEPT AS OTHERWISE PROVIDED IN THIS SUBSECTION, ALL LOADBEARING WALLS, COLUMNS AND ARCHES IN THE STOREY IMMEDIATELY BELOW A FLOOR OR ROOF ASSEMBLY	EXIT SIGNS:	YES				
	SHALL HAVE A <i>FIRE-RESISTANCE RATING</i> OF NOT LESS THAN THAT REQUIRED FOR THE SUPPORTED FLOOR OR ROOF ASSEMBLY. [9.10.8.3.]	EMERGENCY LIGHTING:	YES				
TRAVEL DISTANCE:	AT LEAST 2 EXITS SHALL BE PROVIDED FROM EVERY FLOOR AREA, SPACED SO THAT THE	FIRE DAMPERS:	YES				
	TRAVEL DISTANCE TO THE NEAREST <i>EXIT</i> IS NOT MORE THAN 30m [9.9.8.2.(1)(c)]. THE MAXIMUM TRAVEL DISTANCE FROM ANY POINT ON A MEZZANINe TO THE NEAREST EXIT	PIPING FIRE STOPS:	YES				
SHALL BE NOT MORE THAN IS 30m. [9.9.8.6.(4)] RATED ROOMS: WALLS TO BE BUILT TO THE UNDERSIDE OF STRUCTURE. UNDERSIDE OF STRUCTURE TO		STANDPIPE AND HOSE SYSTEM REQ:	NO				
RATED ROOMS:	INCLUDE DECKING AND OTHER STRUCTURAL COMPONENTS COORDINATE WITH STRUCTURAL DRAWINGS. WHERE ALL ARCHITECTURAL WALLS INTERSECT UNDER JOISTS, BEAMS AND OTHER STRUCTURAL COMPONENTS. ENSURE WALL IS CONTINUOUS CONSTRUCTION TO UNDERSIDE OF DECKING COORDINATE ALL STRUCTURAL JOIST COMPONENTS TO AVOID LINING UP PARALLEL WITH TOP OF WALLS	BARRIER FREE DESIGN [3.8]:	AND THE	BUILDING MUS	THIS SECTION A ST COMPLY WITH IS WITH PHYSICA BILITIES.	ALL REQUIREME	ENTS TO

NOTES

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CLEARHILLS COUNTY

CLEARHILLS FIREHALL

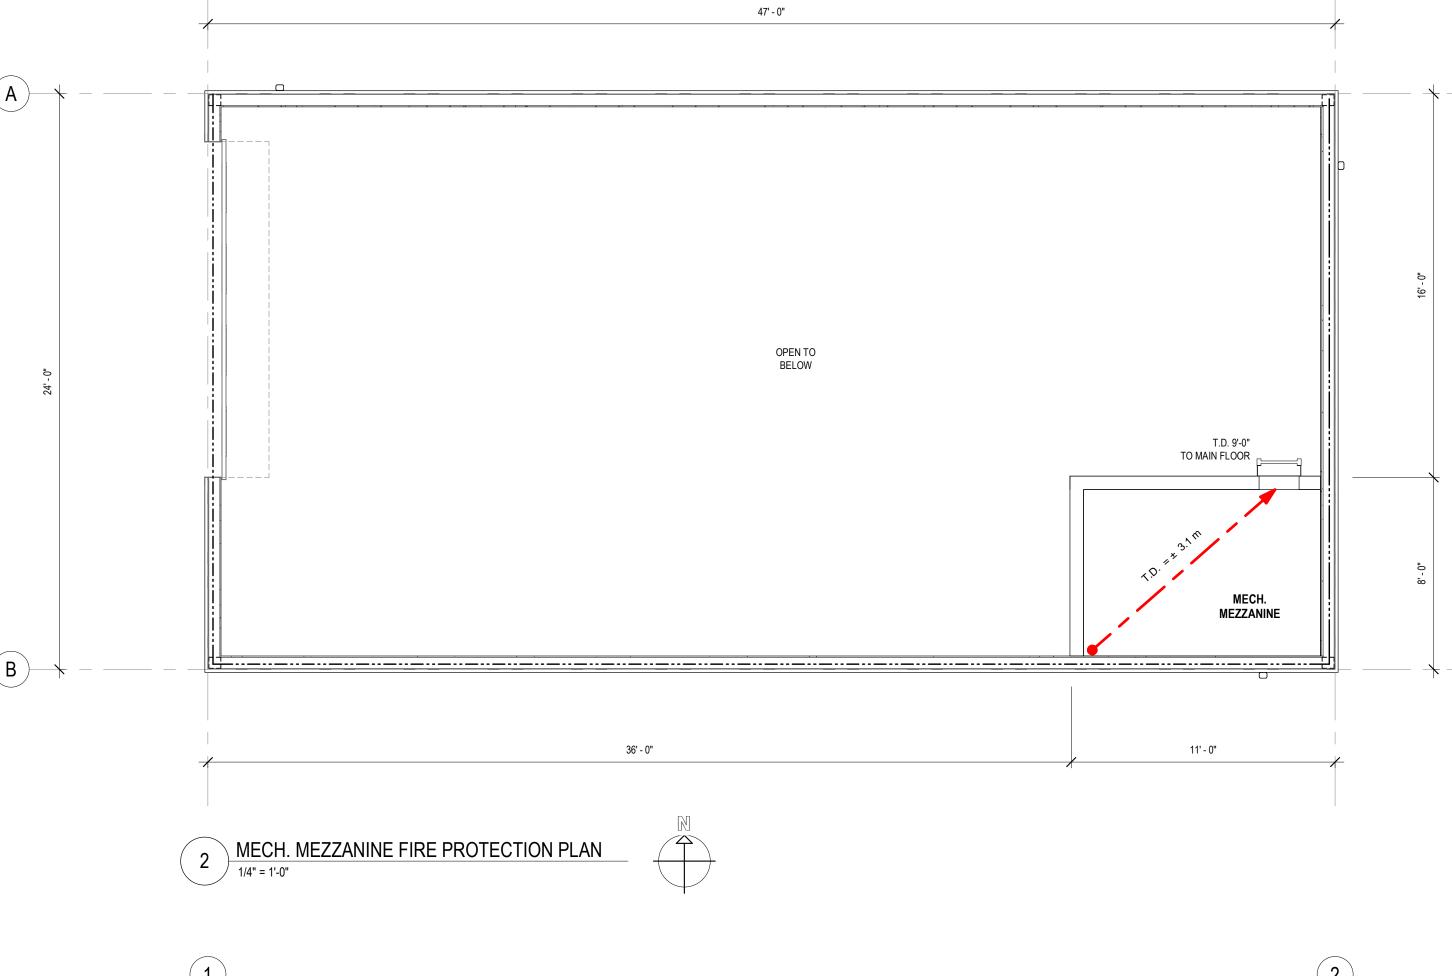SITE DESCRIPTION: LOT 84 & 85, BLOCK 1, PLAN 07262595, CLEARDALE, CLEARHILLS COUNTY, AB

FIRE PROTECTION PLAN

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DRAWING NUMBER:			REVISION:	
SPA PROJECT NUMBER:				20-04
TECH. REVIEW:	RM	FINAL REVIE	W:	E
DRAWN BY:	MC	PROF. REVIE	EW:	E

ADDITIONAL WORK.

NOTES DO NOT SCALE THIS DRAWING. REFER TO GIVEN DIMENSIONS. REPORT ANY DISCREPANCIES OR OMISSIONS TO THE CONSULTANT

IMMEDIATELY. FAILURE TO DO SO SHALL NOT BE GROUNDS FOR

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REVISION SCHEDULE

2020.04.15

2020.04.21

2020.05.20

2020.06.02

ISSUED FOR: CONCEPTUAL CONCEPTUAL 90% CLIENT REVIEW TENDER

CLEARHILLS COUNTY

CLEARHILLS FIREHALL

SITE DESCRIPTION: LOT 84 & 85, BLOCK 1, PLAN 07262595, CLEARDALE, CLEARHILLS COUNTY, AB

FLOOR PLANS

PREFINISHED METAL DOWNSPOUT C/W CONCRETE SPLASHPAD

SHOWER ROOM

11' - 0"

MC PROF. REVIEW: DRAWN BY:

RM FINAL REVIEW: TECH. REVIEW: SPA PROJECT NUMBER: DRAWING NUMBER:

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2. ALL GYPSUM BOARD (DRYWALL) SHALL BE FIRE RATED TYPE-'X' UNLESS OTHERWISE SPECIFICALLY NOTED. 3. PROVIDE 2"x4" WOOD BLOCKING (PRESSURE TREATED) RIGIDLY FASTENED AROUND OPENING OF EXTERIOR DOORS AND WINDOWS. TRIM, OR SHIM AS REQUIRED.

4. PROVIDE CONTINUOUS SEALANT AROUND ALL DOOR AND WINDOW FRAMES. 5. ALL G.I. FLASHINGS EXPOSED TO VIEW FROM GROUND LEVEL SHALL BE PREFINISHED.

GENERAL CONSTRUCTION NOTES:

6. PROVIDE ACOUSTICAL SEALANT AT JUNCTIONS OF FIRE OR SOUND RATED PARTITIONS

7. PREP ALL FLOORS TO RECEIVE NEW SPECIFIED FINISHES. REFER TO ALL FINISHES PLANS. 8. MAINTAIN CONTINUITY OF THERMAL AND AIR / VAPOUR BARRIER BETWEEN EXTERIOR WALL AND ROOF CONSTRUCTION BY FOLLOWING THESE PROCEDURES:

9. FILL TOP AND BOTTOM FLUTES OF STEEL ROOF DECK OVER THE TOP OF EXTERIOR WALLS, BEAMS OR JOISTS WITH SPRAYED POLYURETHANE FOAM. FIREPROOF SURFACE OF FOAM FACING

10. COAT OUTER SURFACE OF ALL STEEL MEMBERS CROSSING EXTERIOR WALL WITH 2" THICK SPRAYED POLYURETHANE FOAM EXTENDING 24" BEYOND EXTERIOR WALL FACE.

11. FILL VOID OF HOLLOW STEEL SECTION BEAMS AND COLUMNS WITH SPRAYED POLYURETHANE FOAM WHERE THEY CROSS EXTERIOR OF BUILDING TO PREVENT COLD AIR MIGRATION

THROUGH THE HOLLOW TUBE

12. PUMP SPRAY POLYURETHANE FOAM INTO THE VOID OF ALL EXTERIOR DOOR AND WINDOW FRAMES AND SPACE AGAINST THE 13. WALL OPENING TO COMPLETE THE SEALING OF AIR / VAPOUR BARRIER MEMBRANE AROUND THE FRAMES. CONTRACTORS, TRADE CONTRACTORS, SUB-CONTRACTORS AND INSTALLERS SHALL ENSURE ALL EXTERIOR FINISHES, VENEERS AND FACADES ARE CONSTRUCTED OR INSTALLED UTILIZING A MINIMUM 10mm (1/2") RAINSCREEN DRAINAGE LAYER IN ACCORDANCE WITH

NRC CNRC CONSTRUCTION TECHNOLOGY UPDATE NO. 34. RAINSCREEN DRAINAGE SYSTEM SPECIFICATIONS AND INSTALLATION PROCEDURES SHALL BE SUBMITTED TO THE CONSULTANT FOR REVIEW PRIOR TO INSTALLATION. THE CONSULTANT DOES NOT APPROVE, WARRANTEE OR GUARANTEE THE INSTALLATION OF ANY EXTERIOR FINISH OR BUILDING ENVELOPE COMPONENT THAT DOES NOT MAINTAIN RAINSCREEN TECHNOLOGY.

14. OVERLAP PEEL & STICK AIR / VAPOUR MEMBRANE SHEETS MINIMUM 4". APPLY CONTINUOUS BEAD OF CAULKING AND OVERLAP ALL LOCATIONS. 15. ALL WOOD COMPONENTS DIRECTLY ATTACHED TO CEMENTITIOUS MATERIALS AND DIRECTLY UNDER EXTERIOR ALUMINUM SILLS SHALL BE PRESSURE TREATED.

16. CONSTRUCT ALL INTERIOR PARTITION WALLS TO U/S OF STRUCTURE (U.N.O.)

17. SOUND ABSORPTIVE MATERIAL SHOULD NOT OVERFILL THE CAVITY TO THE POINT OF PRODUCING SIGNIFICANT OUTWARD PRESSURE ON THE FINISHES; SUCH AN ASSEMBLY WILL NOT ACHIEVE THE S.T.C. RATING. WHERE THE ABSORPTIVE MATERIAL USED WITH STEEL STUD ASSEMBLIES IS IN BATT FORM "STEEL STUD BATTS" WHICH ARE WIDE ENOUGH TO FILL THE CAVITY

FROM THE WEB OF ONE STUD TO THE WEB OF THE ADJACENT STUD MUST BE USED.

18. IN ALL LOCATIONS WHERE GYPSUM BOARD ABUTS DISSIMILAR MATERIAL USE A MILCOR AND / OR J-TRIM @ EDGE SURFACES. 19. PROVIDE CORNER BEAD FOR ALL EXPOSED GYPSUM SHEATHING CORNERS.

20. FURR-IN ALL EXPOSED MECHANICAL AND/OR ELECTRICAL COMPONENTS, IN FINISHED AREAS WITH 5/8" GYPSUM SHEATHING & STEEL STUD FRAMING.

21. CONTRACTOR TO PATCH AND REPAIR ALL WORK ASSOCIATED WITH MECHANICAL AND ELECTRICAL SERVICE TIE-INS INCLUDING ALL REQUIRED CORING. 22. REFER TO MECHANICAL AND ELECTRICAL FOR DIFFUSERS, GRILLES FIXTURES AND EQUIPMENT: COORDINATE SIZES AND EXACT LOCATIONS TO SUIT ARCHITECTURAL REFLECTED CEILING PLAN AND/OR DETAILS.

23. INSTALL FIRE STOPPING AROUND ALL MECH. & ELEC. PENETRATIONS THROUGH FIRE RATED WALLS AND CEILINGS. 24. THE CONSULTANT IS NOT RESPONSIBLE FOR THE ACCURACY OF THE SURVEY.

R-24 BATT INSULATION

6mil POLY VAPOUR BARRIER

AIR BARRIER MEMBRANE

R-24 BATT INSULATION

1/2" PLYWOOD SHEATHING

6mil POLY VAPOUR BARRIER

2HR FIRE RESISTANCE RATING | 1/2" PLYWOOD STIEATHING 2x6" WOOD STUDS AS PER STRUCTURAL

5/8" TYPE 'X' GYPSUM SHEATHING

EXTERIOR CORRUGATED METAL CLADDING

2-PLY 5/8" TYPE 'X' GYPSUM SHEATHING

25. REFER ALSO TO SECTIONS AND ELEVATIONS FOR BRICK COURSING, STUCCO PATTERNS AND REVEALS. 26. THE CONSULTANT INDICATES FOR COORDINATION PURPOSES ONLY THE STRUCTURAL, MECHANICAL, ELECTRICAL, SITE GRADING, ETC. INFORMATION. REFER TO THE APPROPRIATE

ENGINEERING DRAWINGS BEFORE PROCEEDING WITH THE WORK.

27. DO NOT SCALE DRAWINGS.

28. ALL ARCHITECTURAL SYMBOLS INDICATED ARE GRAPHIC REPRESENTATIONS ONLY.

 SYMBOL INDICATES WALL TAG. REFER TO WALL SCHEDULE SHEET A6.1. DOOR SCHEDULE SHEET A6.1. WINDOW SCHEDULE SHEET A6.1.

A3.1

\ A3.1 /

4' - 0"

MAIN FLOOR PLAN

B

FLOOR PLAN NOTES


WALL SCHEDULE * REFER TO ELEVATION S FOR CHANGES IN CLADDING COLOR AND ORIENTATION WALL DESCRIPTION INTERIOR WALLS WALL DESCRIPTION EXTERIOR WALLS WALL DIAGRAM 5/8" GYPSUM SHEATHING EXTERIOR CORRUGATED METAL CLADDING AIR BARRIER MEMBRANE 2x6 WOOD STUDS @ 16" O/C 1/2" PLYWOOD SHEATHING R-24 BATT INSULATION 2x6" WOOD STUDS AS PER STRUCTURAL 5/8" GYPSUM SHEATHING 3'-0" HIGH METAL LINER PANEL R-24 BATT INSULATION 6mil POLY VAPOUR BARRIER 5/8" GYPSUM SHEATHING 5/8" GYPSUM SHEATHING 3'-0" HIGH METAL LINER PANEL PONYWALL 2x6 WOOD STUDS @ 16" O/C 3'-6" ABOVE FINISHED FLOOR 5/8" GYPSUM SHEATHING EXTERIOR CORRUGATED METAL CLADDING AIR BARRIER MEMBRANE 1HR FIRE RESISTANCE RATING | 1/2" PLY WOOD STILLATIONS | 2x6" WOOD STUDS AS PER STRUCTURAL 5/8" GYPSUM SHEATHING 2x4 WOOD STUDS @ 16" O/C R-24 BATT INSULATION 6mil POLY VAPOUR BARRIER 5/8" TYPE 'X' GYPSUM SHEATHING 3'-0" HIGH METAL LINER PANEL CONTRACTORS, TRADE CONTRACTORS, SUB-CONTRACTORS AND INSTALLERS SHALL ENSURE ALL EXTERIOR FINISHES, VENEERS EXTERIOR CORRUGATED METAL CLADDING AND FACADES ARE CONSTRUCTED OR INSTALLED UTILIZING A MINIMUM 1/2" (10mm) RAINSCREEN DRAINAGE LAYER IN ACCORDANCE AIR BARRIER MEMBRANE WITH NRC CNRC CONSTRUCTION TECHNOLOGY UPDATE NO. 34. RAINSCREEN DRAINAGE SYSTEM SPECIFICATIONS AND 1HR FIRE RESISTANCE RATING | 1/2 PLI WOOD STUDS AS PER STRUCTURAL 2x6" WOOD STUDS AS PER STRUCTURAL INSTALLATION PROCEDURES SHALL BE SUBMITTED TO THE CONSULTANT FOR REVIEW PRIOR TO INSTALLATION. THE CONSULTANT


DOES NOT APPROVE, WARRANTEE OR GUARANTEE THE INSTALLATION OF ANY EXTERIOR FINISH OR BUILDING ENVELOPE COMPONENT THAT DOES NOT MAINTAIN RAINSCREEN TECHNOLOGY CONTROL JOINTS ARE TO BE PROVIDED AT A MAXIMIUM 13'-0" (4m) O.C. HORIZONTAL AND VERTICAL FOR ALL EXTERIOR FINISHES,

OR AS RECOMMENDED BY MANUFACTURER'S SPEFICATIONS.

2-PLY 5/8" TYPE 'X' GYPSUM SHEATHING 3'-0" HIGH METAL LINER PANEL EXTERIOR CORRUGATED METAL CLADDING AIR BARRIER MEMBRANE 1/2" PLYWOOD SHEATHING · 2HR FIRE RESISTANCE RATING | 2x6" WOOD STUDS AS PER STRUCTURAL R-24 BATT INSULATION 6mil POLY VAPOUR BARRIER

> 11' - 0" 7' - 0" 4' - 0" PLUMBING FIXTURES AS PER MECH. F.D. AS SHOWER ROOM B/F SHOWER MIN. 3'-0" x 5'-0" AS PER MECH. B/F SHOWER CLEARANCE B

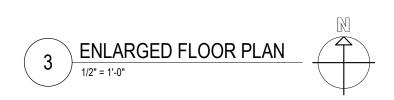

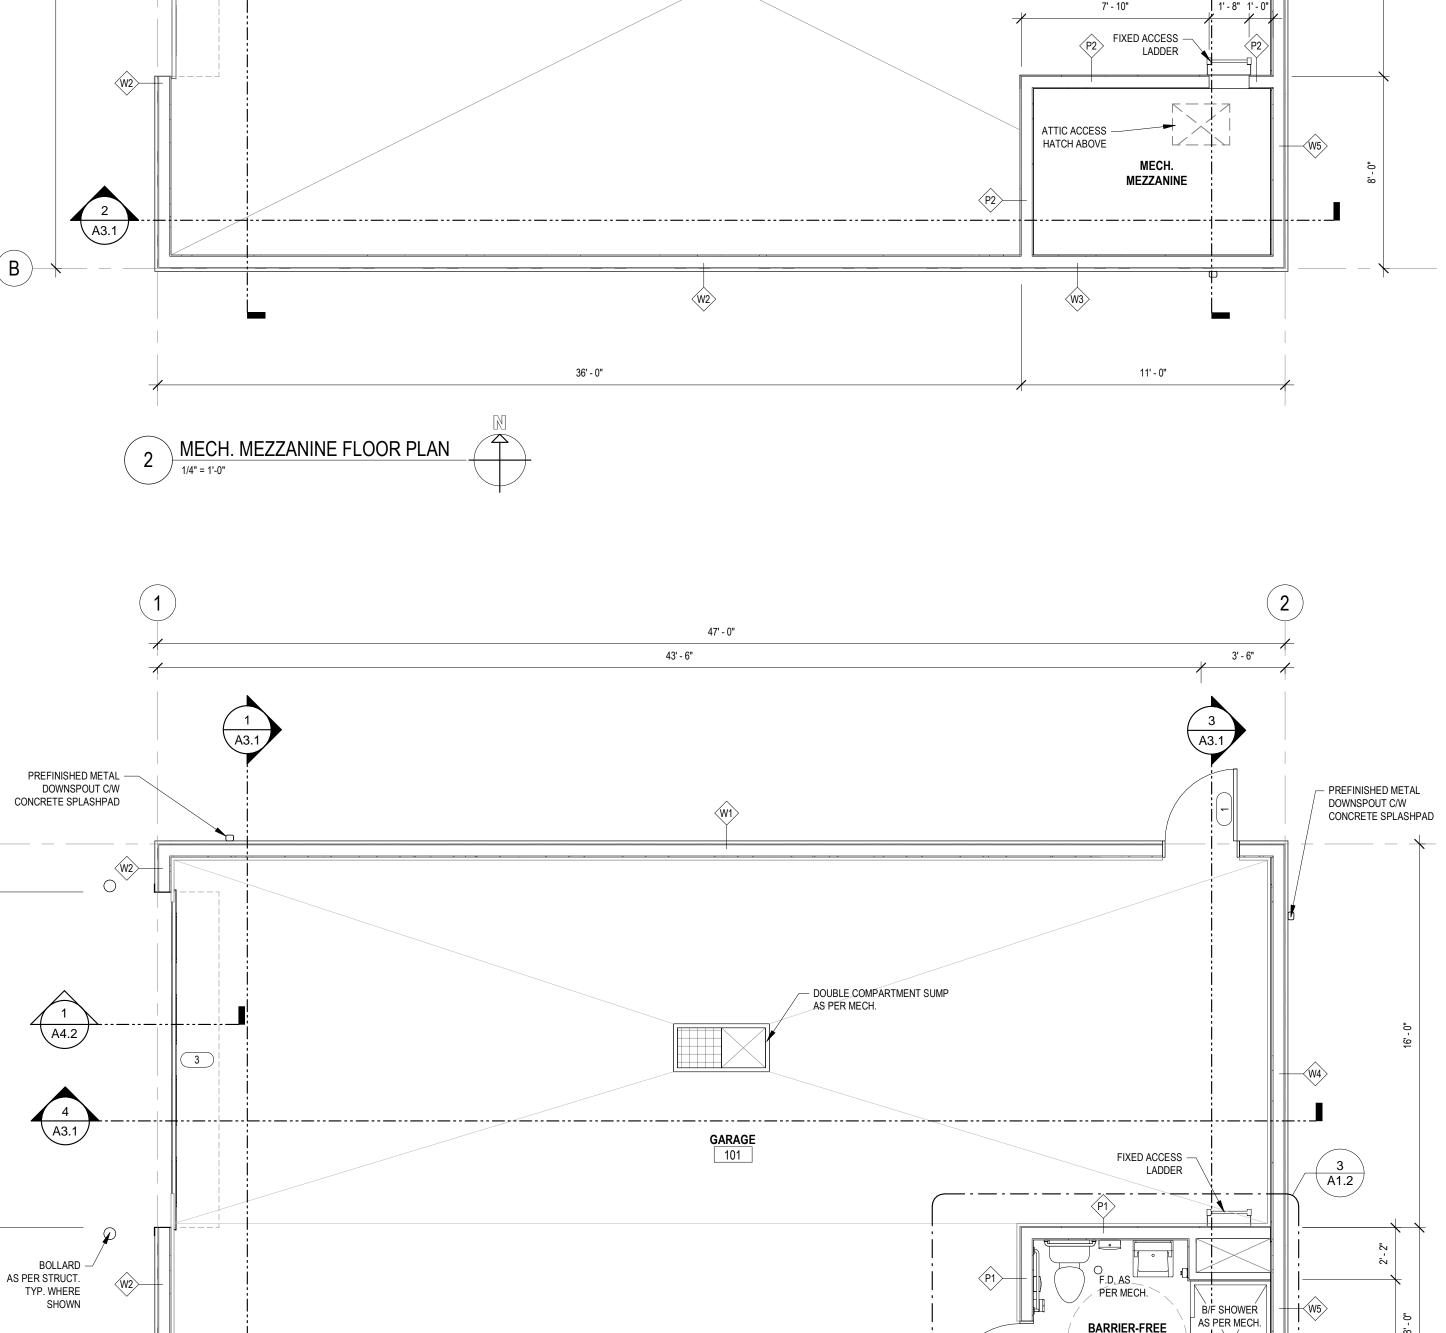

32' - 0"

47' - 0"

BELOW

2. SYMBOL INDICATES DOOR TAG. REFER TO 3. SYMBOL INDICATES WINDOW TAG. REFER TO 4. REFER TO STRUCTURAL DRAWINGS FOR ALL FOUNDATION AND STRUCTURAL INFORMATION.

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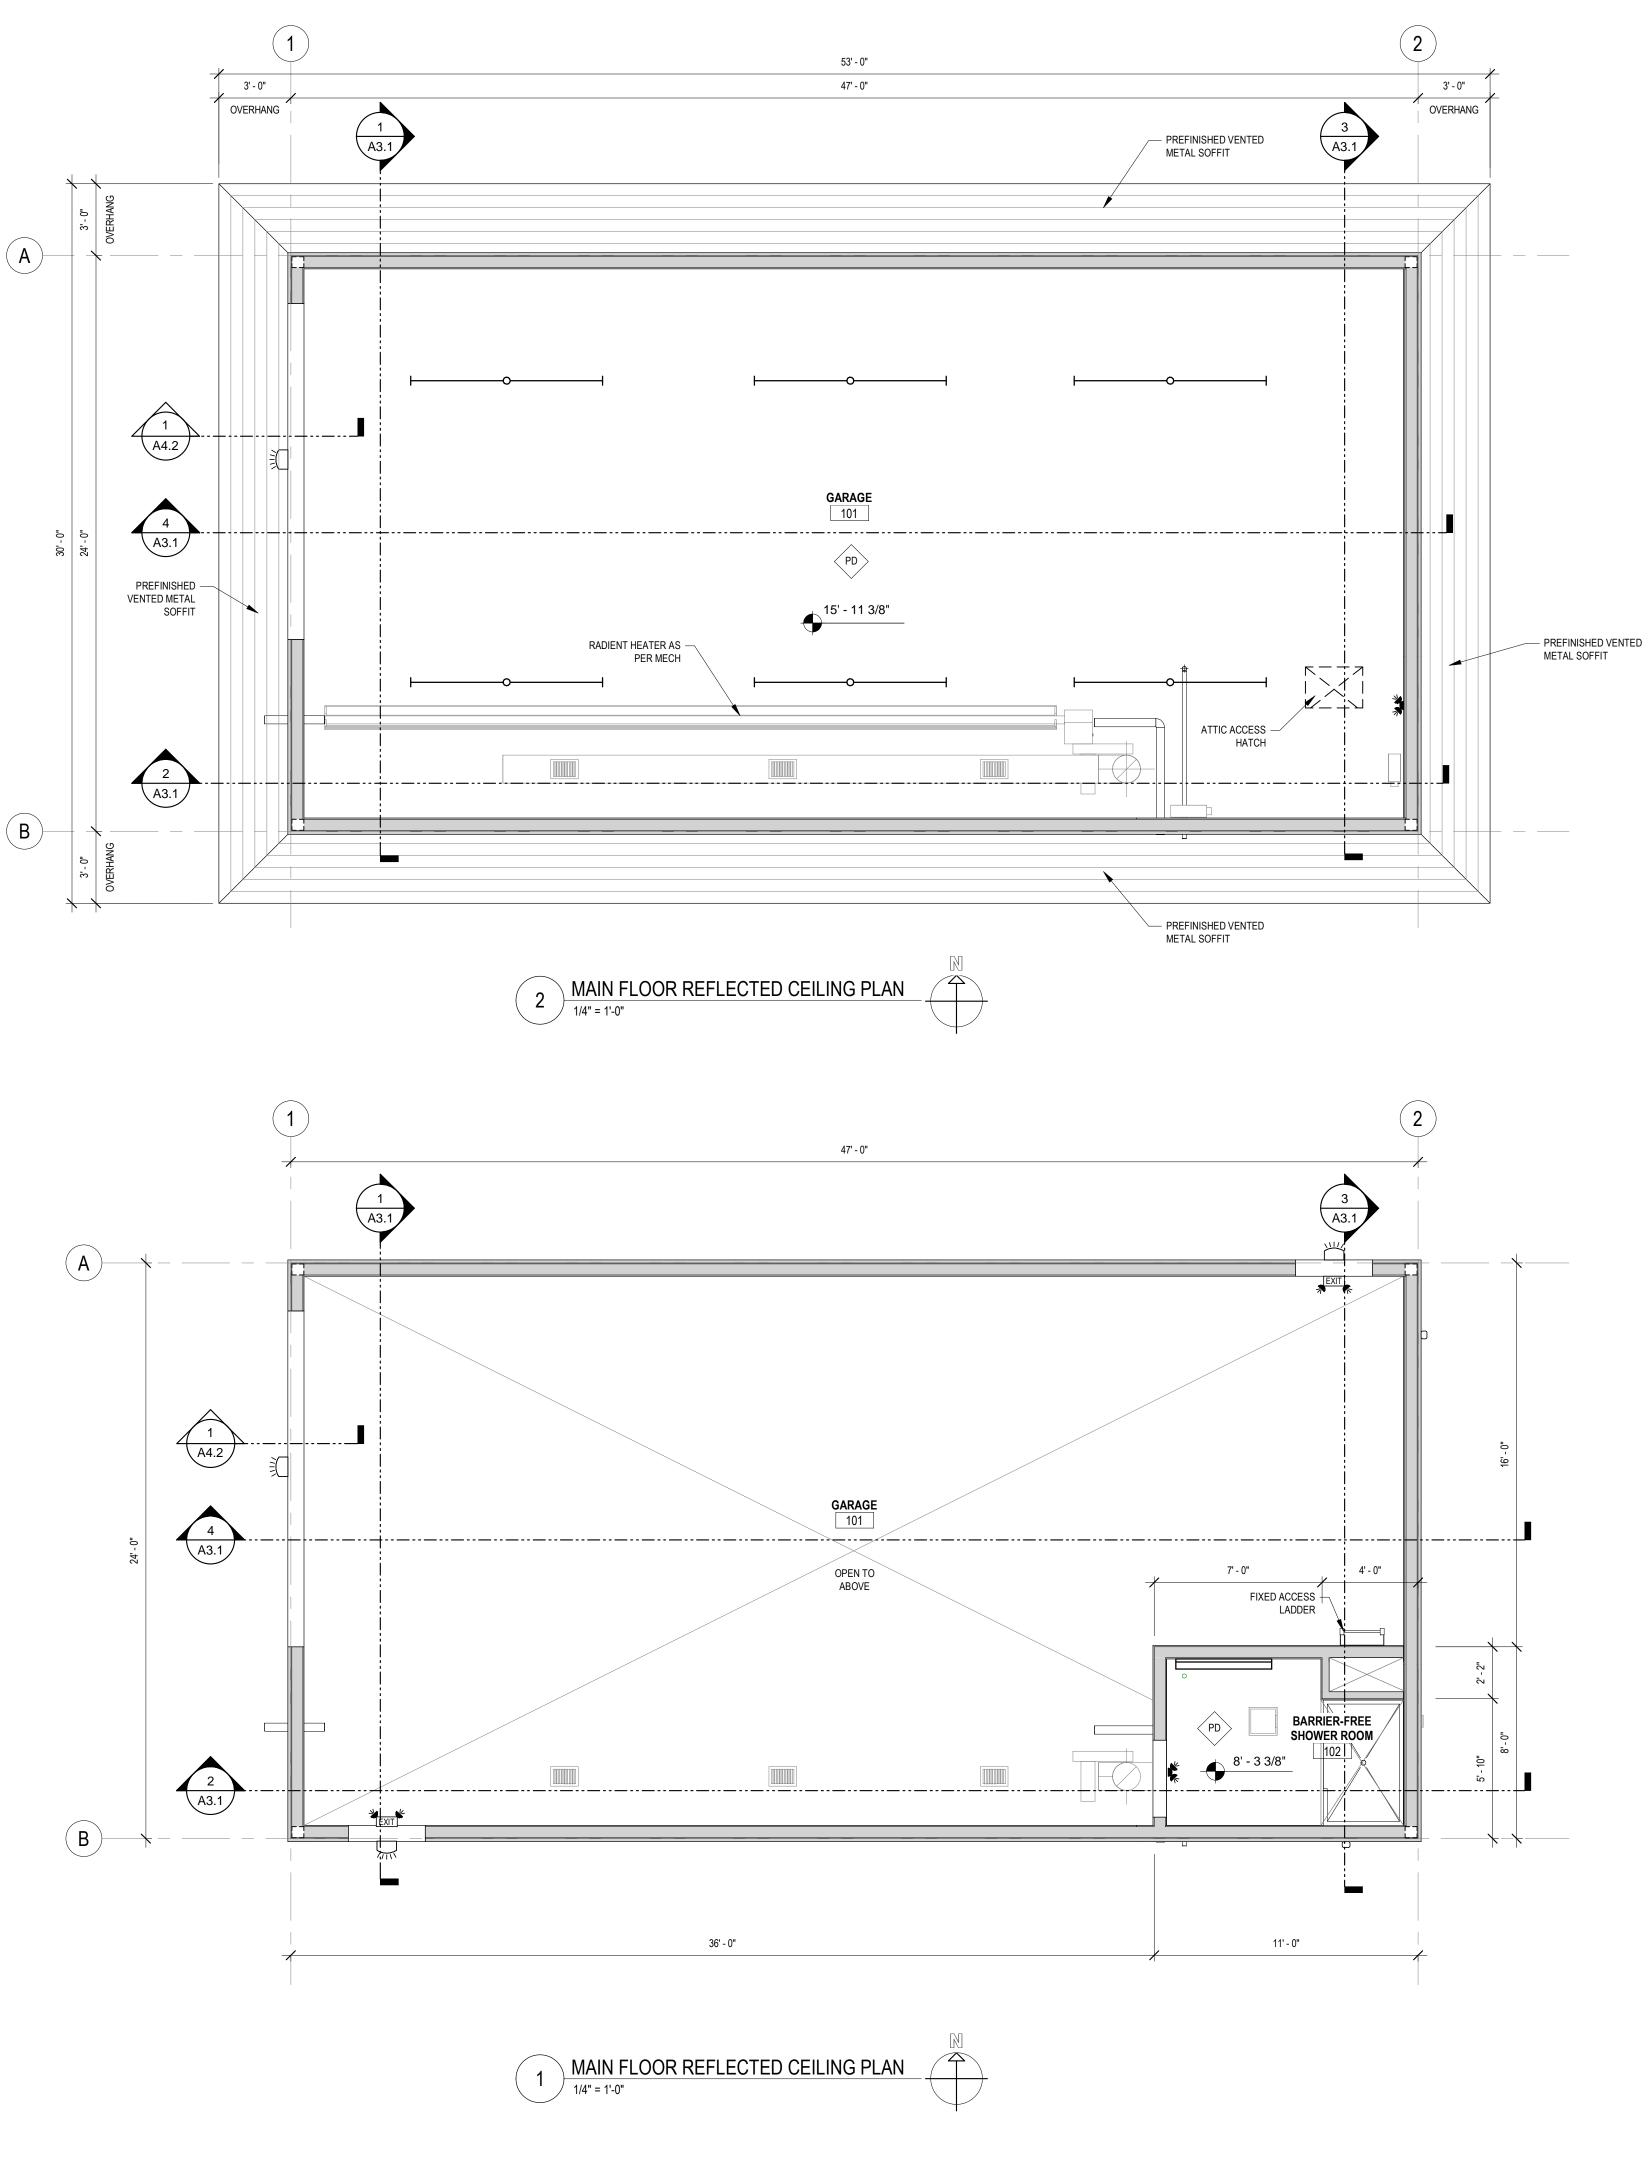
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REFLECTED CEILING P	LAN LEGEND
	INDICATES 2'-0" x 2'-0" SUSPENDED ACOUSTIC UNIT CEILING
PD	PAINTED DRYWALL
2PD	2 LAYERS OF PAINTED DRYWALL
EXS	EXPOSED STRUCTURE
###	CEILING ELEVATION (A.F.F.)
	LIGHT FIXTURE - RECESSED LED
	LIGHT FIXTURE - WALL MOUNT
Ø	LIGHT FIXTURE - PENDANT
├	LIGHT FIXTURE - STRIP LIGHT
	LIGHT FIXTURE - RECESSED DOWNLIGHT
	LIGHT FIXTURE - BATTERY PACK
	LIGHT FIXTURE - EMERGENCY REMOTE LAMPS
↔	LIGHT FIXTURE - EXIT LIGHT
	LIGHT FIXTURE - EXTERIOR WALLPACK
	2'-0" x 4'-0" RECESSED FLUORESCENT LIGHT FIXTURE
REFLECTED CEILING P	LAN NOTES

REFLECTED CEILING PLAN NOTES

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- B. CEILING ELEVATIONS GIVEN ARE HEIGHTS FROM FINISHED FLOOR AT EACH AREA.
- 4. ALL GYPSUM BOARD (GYPSUM SHEATHING) TO BE TYPE 'X'. UNLESS OTHERWISE
- 5. SHADED AREAS INDICATE FIRE RATED ROOMS. WALLS TO BE BUILT TO UNDERSIDE OF DECK. SEE BUILDING CODE ANALYSIS ON DRAWING A0.1.





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PROF. SEAL:

REVISION SCHEDULE			
ISSUED FOR:	REVISION	DATE	
90% CLIENT REVIEW	С	2020.05.	
TENDER	0	2020.06.	

CLEARHILLS COUNTY

CLEARHILLS FIREHALL

SITE DESCRIPTION: LOT 84 & 85, BLOCK 1, PLAN 07262595, CLEARDALE, CLEARHILLS COUNTY, AB

REFLECTED CEILING PLAN

DRAWN BY: MC PROF. REVIEW: TECH. REVIEW: RM FINAL REVIEW: SPA PROJECT NUMBER: DRAWING NUMBER:

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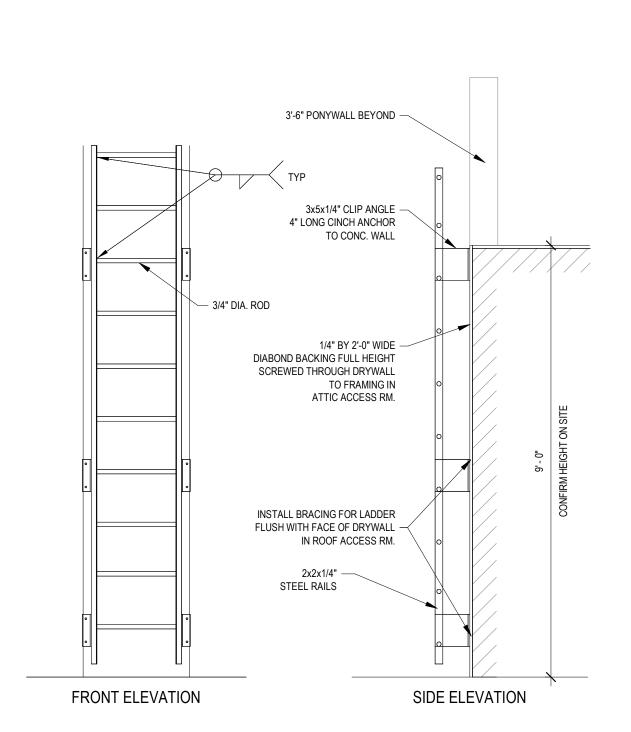
- 1. CONFIRM ALL DIMENSIONS ON SITE PRIOR TO COMMENCING WORK. REPORT ANY DISCREPANCY TO THE CONSULTANT.
- 2. ROOF TOP SERVICES AND ROOF PENETRATIONS ARE SHOWN FOR INFORMATION ONLY. COORDINATE NUMBER AND LOCATION OF OPENINGS & EXTENT OF SERVICES WITH MECHANICAL AND ELECTRICAL DRAWINGS.
- 3. ALL G.I. FLASHINGS EXPOSED TO VIEW FROM GROUND LEVEL SHALL BE PREFINISHED.
- 4. CUT AND REMOVE WALLS, ROOF, ROOFING, ETC. AS REQUIRED TO FACILITATE/ACCOMMODATE THE WORK OF THIS CONTRACT. REINFORCE ALL OPENINGS
- 5. EXTEND RWL MIN 12" FROM BUILDING FACE, C/W CONCRETE SPLASHPAD.

AS DIRECTED BY STRUCTURAL ENGINEER.


ALL ROOF TYPES TO BE READ IN CONJUNCTION



5/8" GYPSUM BOARD





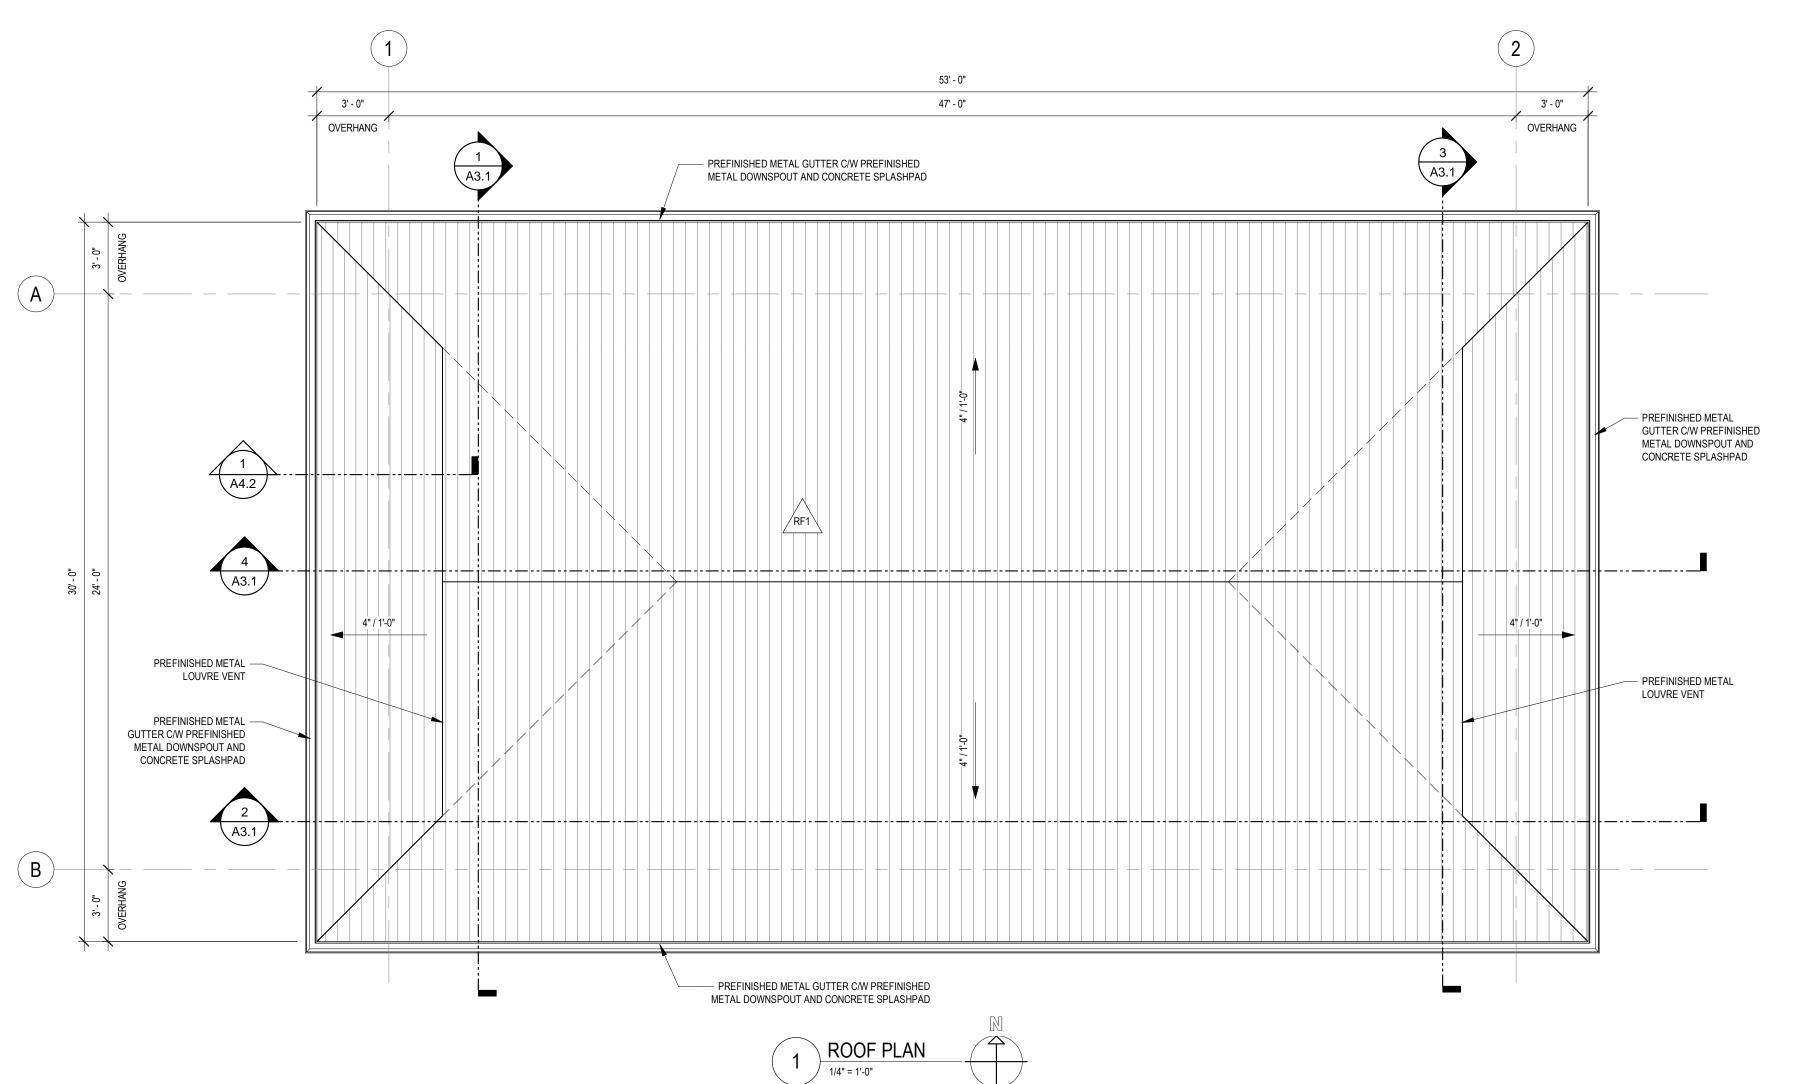

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PROF. SEAL:

REVISI	ON SCHEDULE	
ISSUED FOR:	REVISION	DATE
90% CLIENT REVIEW TENDER	C 0	2020.05.20 2020.06.02

CLEARHILLS COUNTY

CLEARHILLS FIREHALL


SITE DESCRIPTION: LOT 84 & 85, BLOCK 1, PLAN 07262595,

CLEARDALE, CLEARHILLS COUNTY, AB

ROOF PLAN

DRAWN BY:	MC	PROF. REVIE	EW:
TECH. REVIEW:	RM	FINAL REVIE	W:
SPA PROJECT NUMBER:			
DRAWING NUMBER:			REVISION:
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H1.4

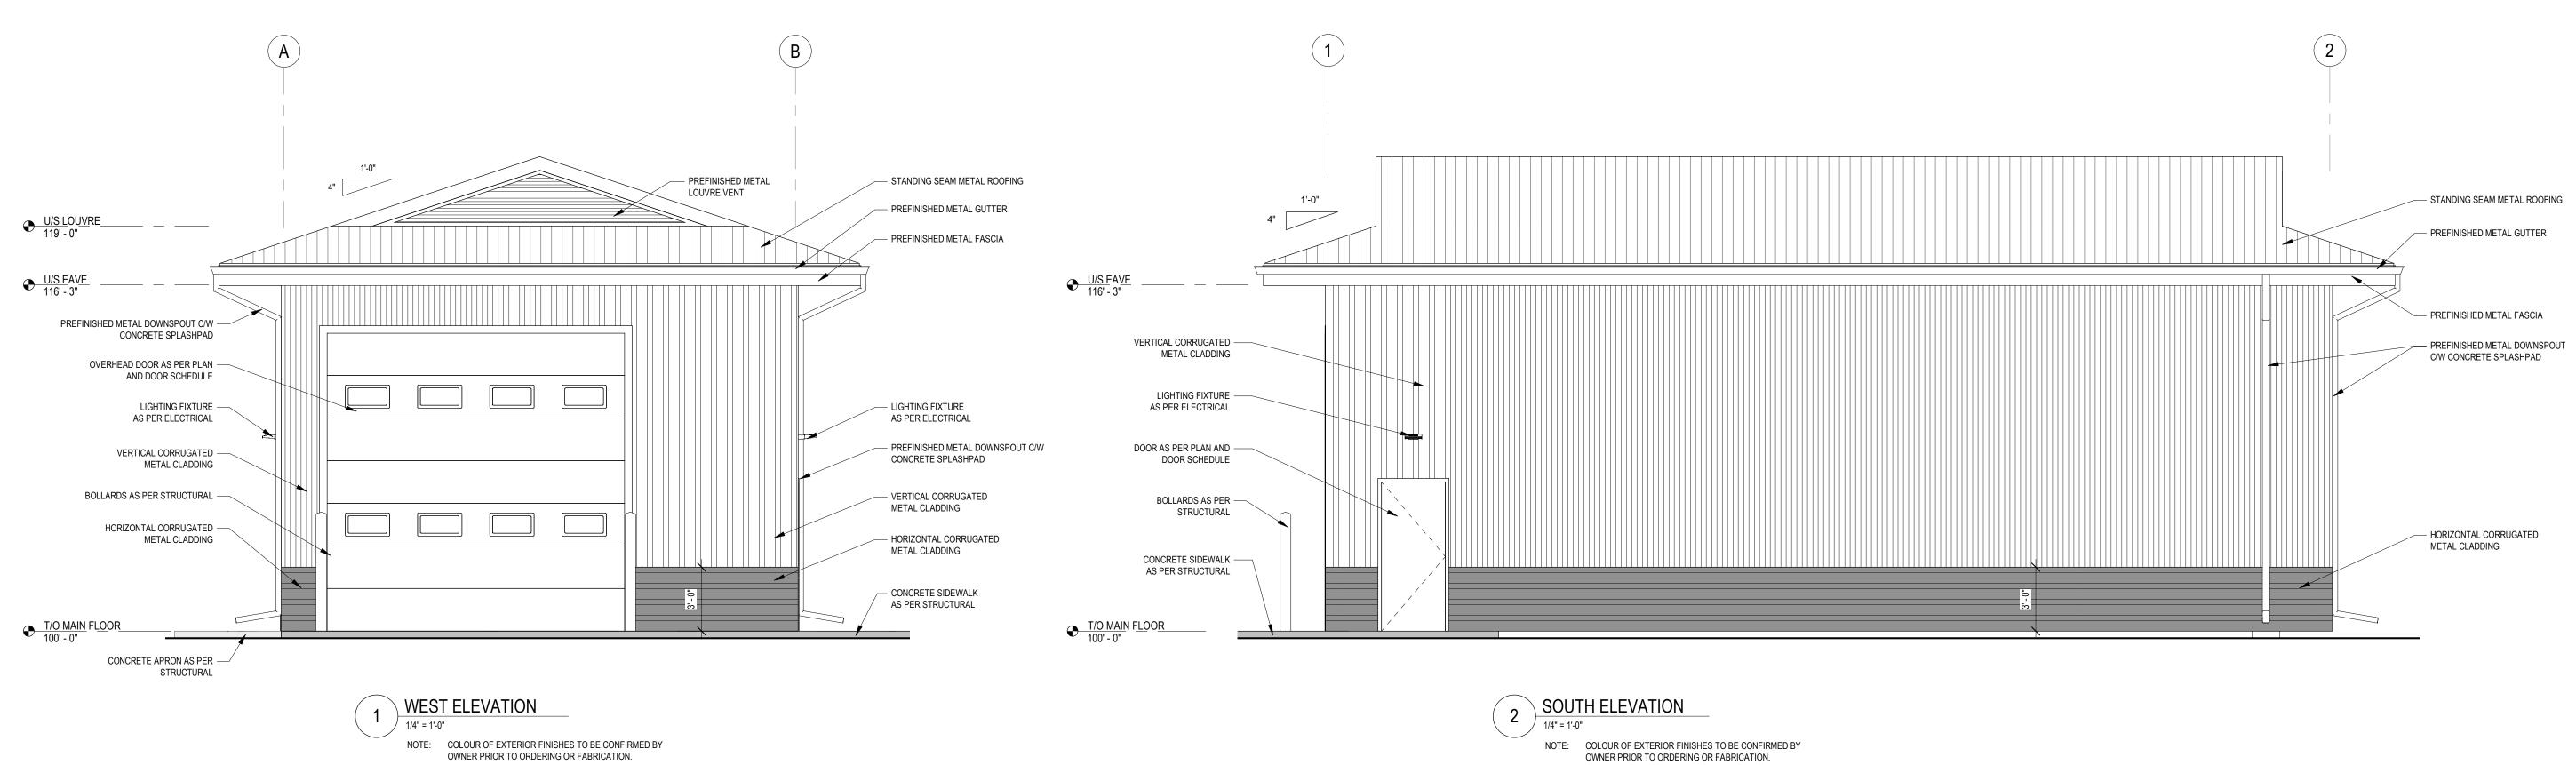

PREFINISHED METAL — STANDING SEAM METAL ROOFING - STANDING SEAM METAL ROOFING LOUVRE VENT - PREFINISHED METAL GUTTER PREFINISHED METAL GUTTER U/S EAVE 116' - 3" — PREFINISHED METAL FASCIA PREFINISHED METAL DOWNSPOUT -C/W CONCRETE SPLASHPAD PREFINISHED METAL — DOWNSPOUT C/W - PREFINISHED METAL DOWNSPOUT C/W PREFINISHED METAL DOWNSPOUT C/W CONCRETE SPLASHPAD CONCRETE SPLASHPAD CONCRETE SPLASHPAD LIGHTING FIXTURE — AS PER ELECTRICAL VERTICAL CORRUGATED METAL CLADDING LIGHTING FIXTURE
 AS PER ELECTRICAL VERTICAL CORRUGATED METAL -CLADDING - HORIZONTAL CORRUGATED METAL CLADDING DOOR AS PER PLAN AND — DOOR SCHEDULE - BOLLARDS AS PER VERTICAL CORRUGATED — STRUCTURAL METAL CLADDING HORIZONTAL CORRUGATED — METAL CLADDING HORIZONTAL CORRUGATED -METAL CLADDING CONCRETE APRON AS PER CONCRETE APRON AS — STRUCTURAL PER STRUCTURAL - CONCRETE SIDEWALK AS PER STRUCTURAL EAST ELEVATION NOTE: COLOUR OF EXTERIOR FINISHES TO BE CONFIRMED BY NOTE: COLOUR OF EXTERIOR FINISHES TO BE CONFIRMED BY OWNER PRIOR TO ORDERING OR FABRICATION. OWNER PRIOR TO ORDERING OR FABRICATION.

NOTES

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IN THE CASE OF A DISCREPANCY BETWEEN THE CONTRACT

DOCUMENTS, DRAWINGS OF LARGER SCALE SHALL GOVERN OVER THOSE OF SMALLER SCALE. - SPECIFICATIONS SHALL GOVERN

OVER DRAWINGS.

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TENDER	0	2020.06.0		


CLEARHILLS COUNTY

CLEARHILLS FIREHALL

SITE DESCRIPTION: LOT 84 & 85, BLOCK 1, PLAN 07262595, CLEARDALE, CLEARHILLS COUNTY, AB

ELEVATIONS

DRAWN BY:	MC	PROF. REVIE	EW:	
TECH. REVIEW:	RM	FINAL REVIE	:W:	
SPA PROJECT NUMBER:			:	20-
DRAWING NUMBER:			REVISION:	
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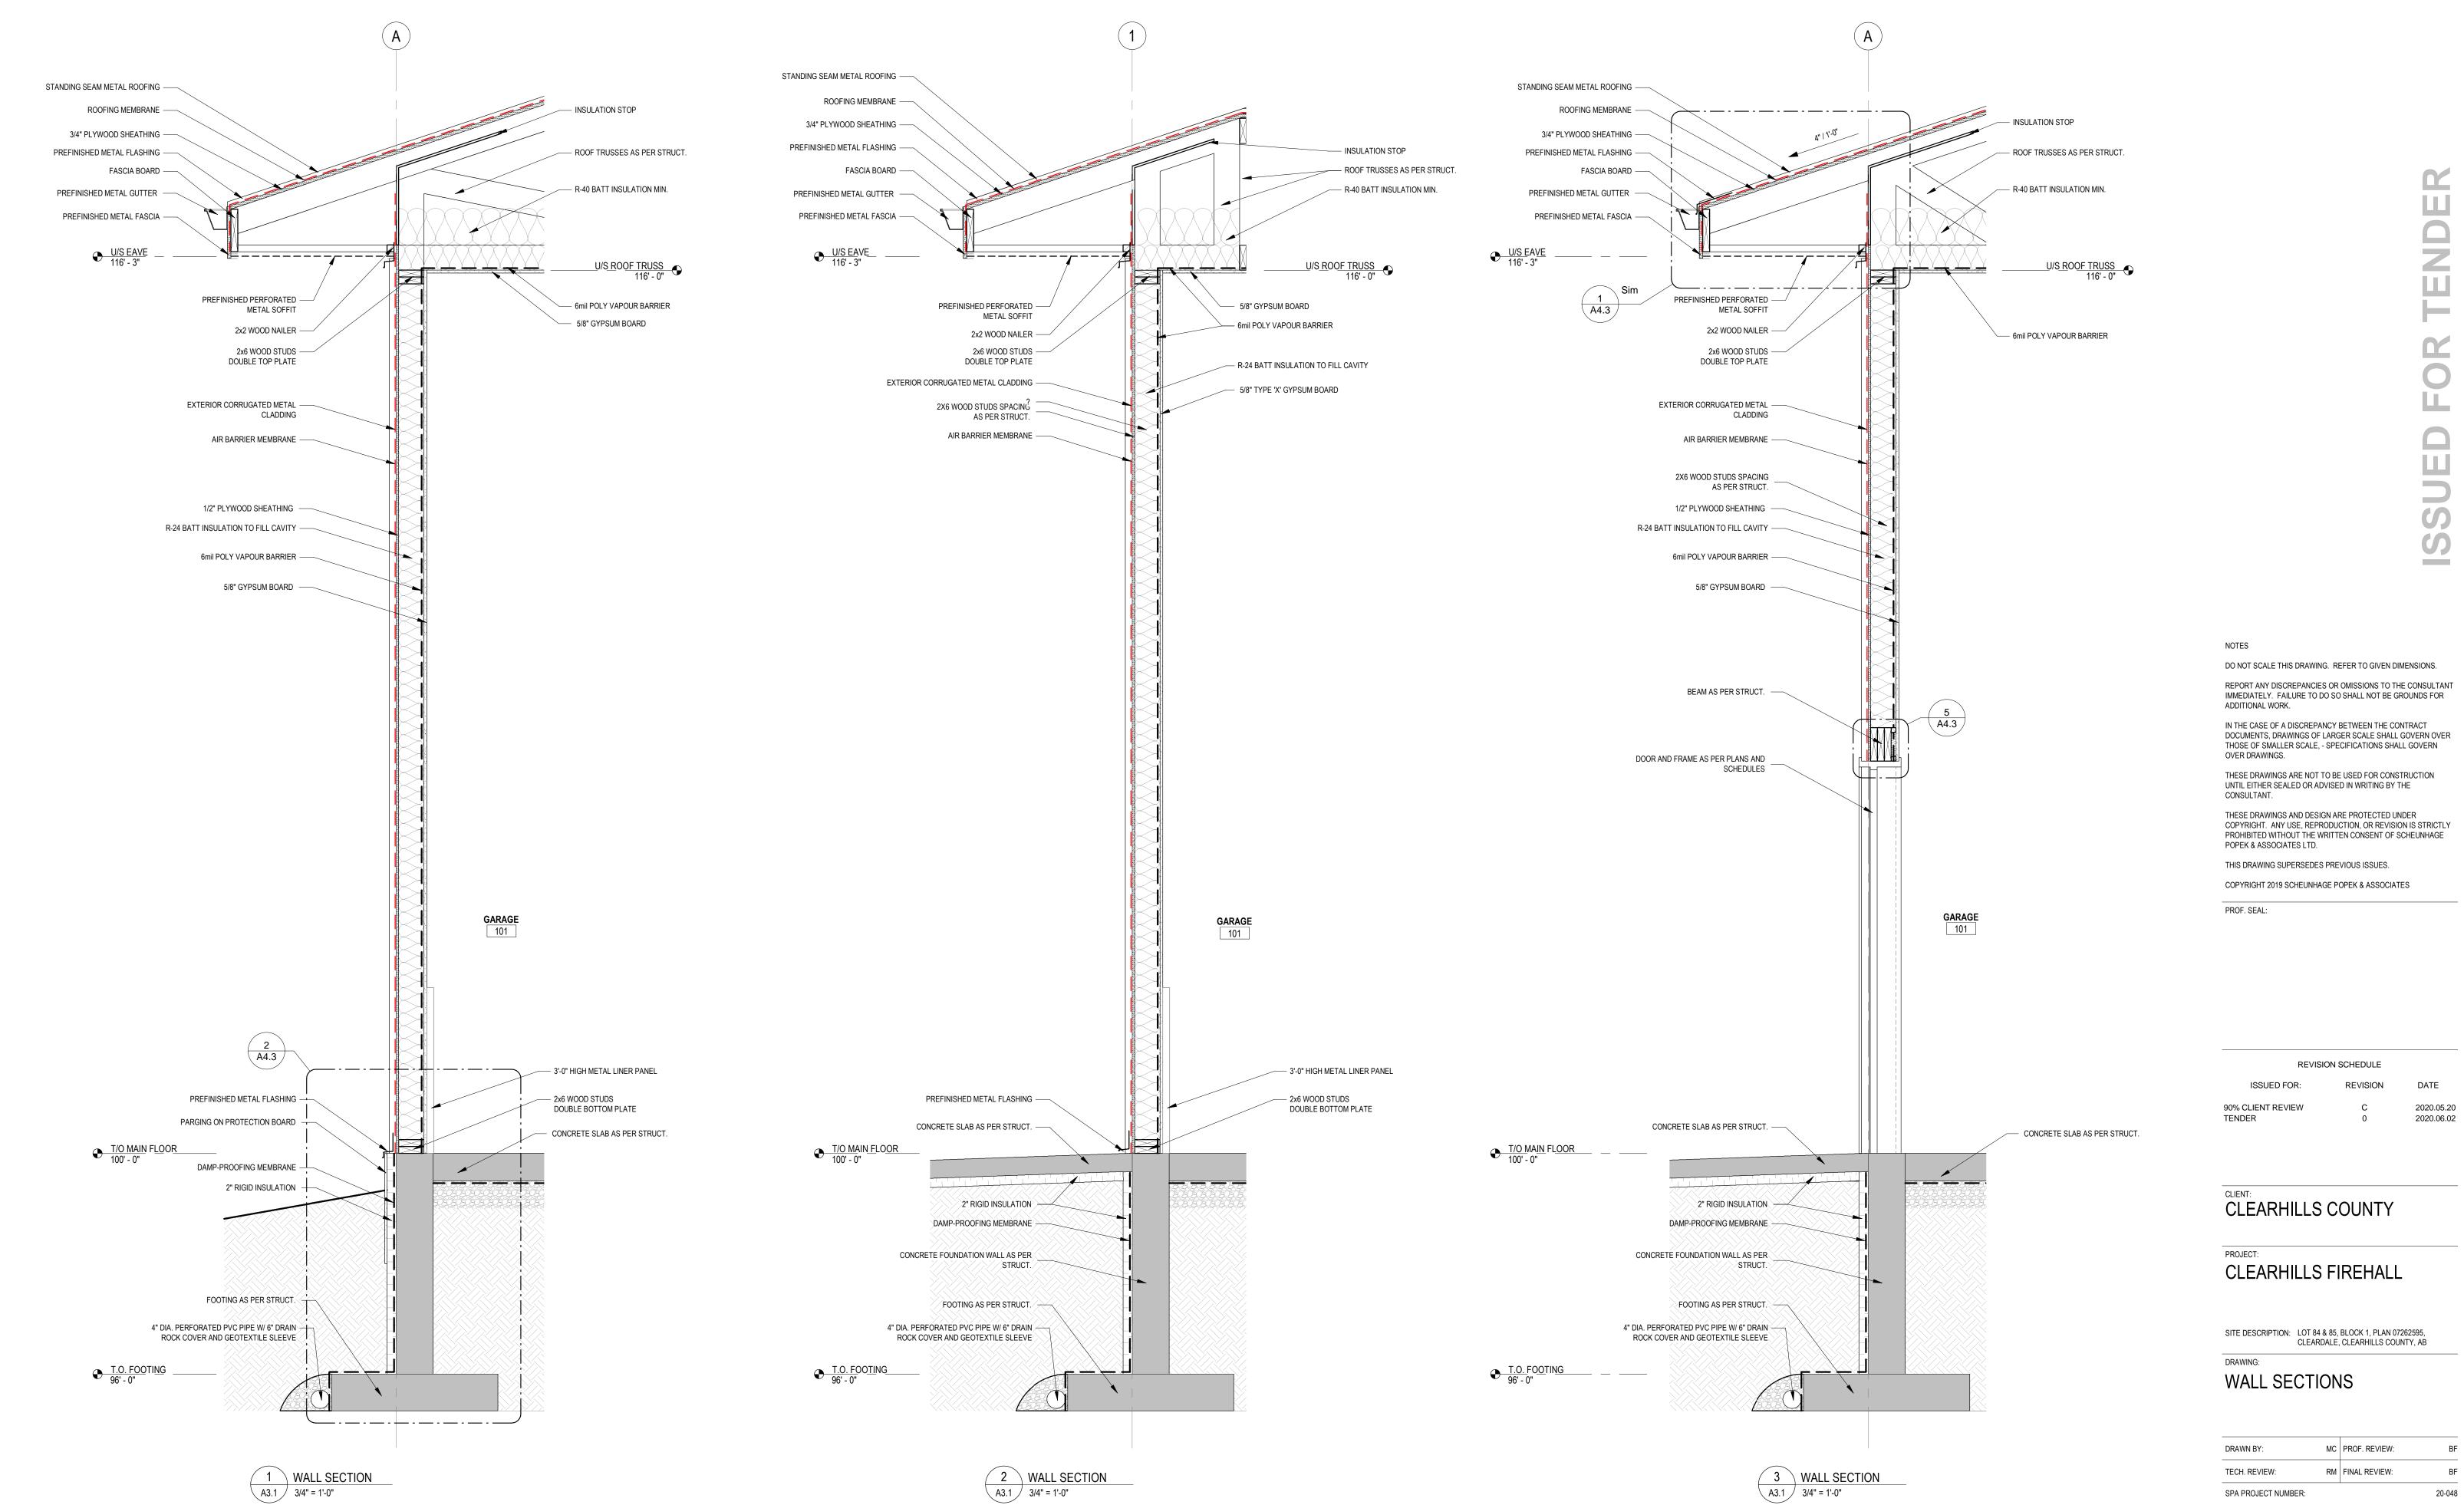
RM FINAL REVIEW: SPA PROJECT NUMBER: DRAWING NUMBER: REVISION:

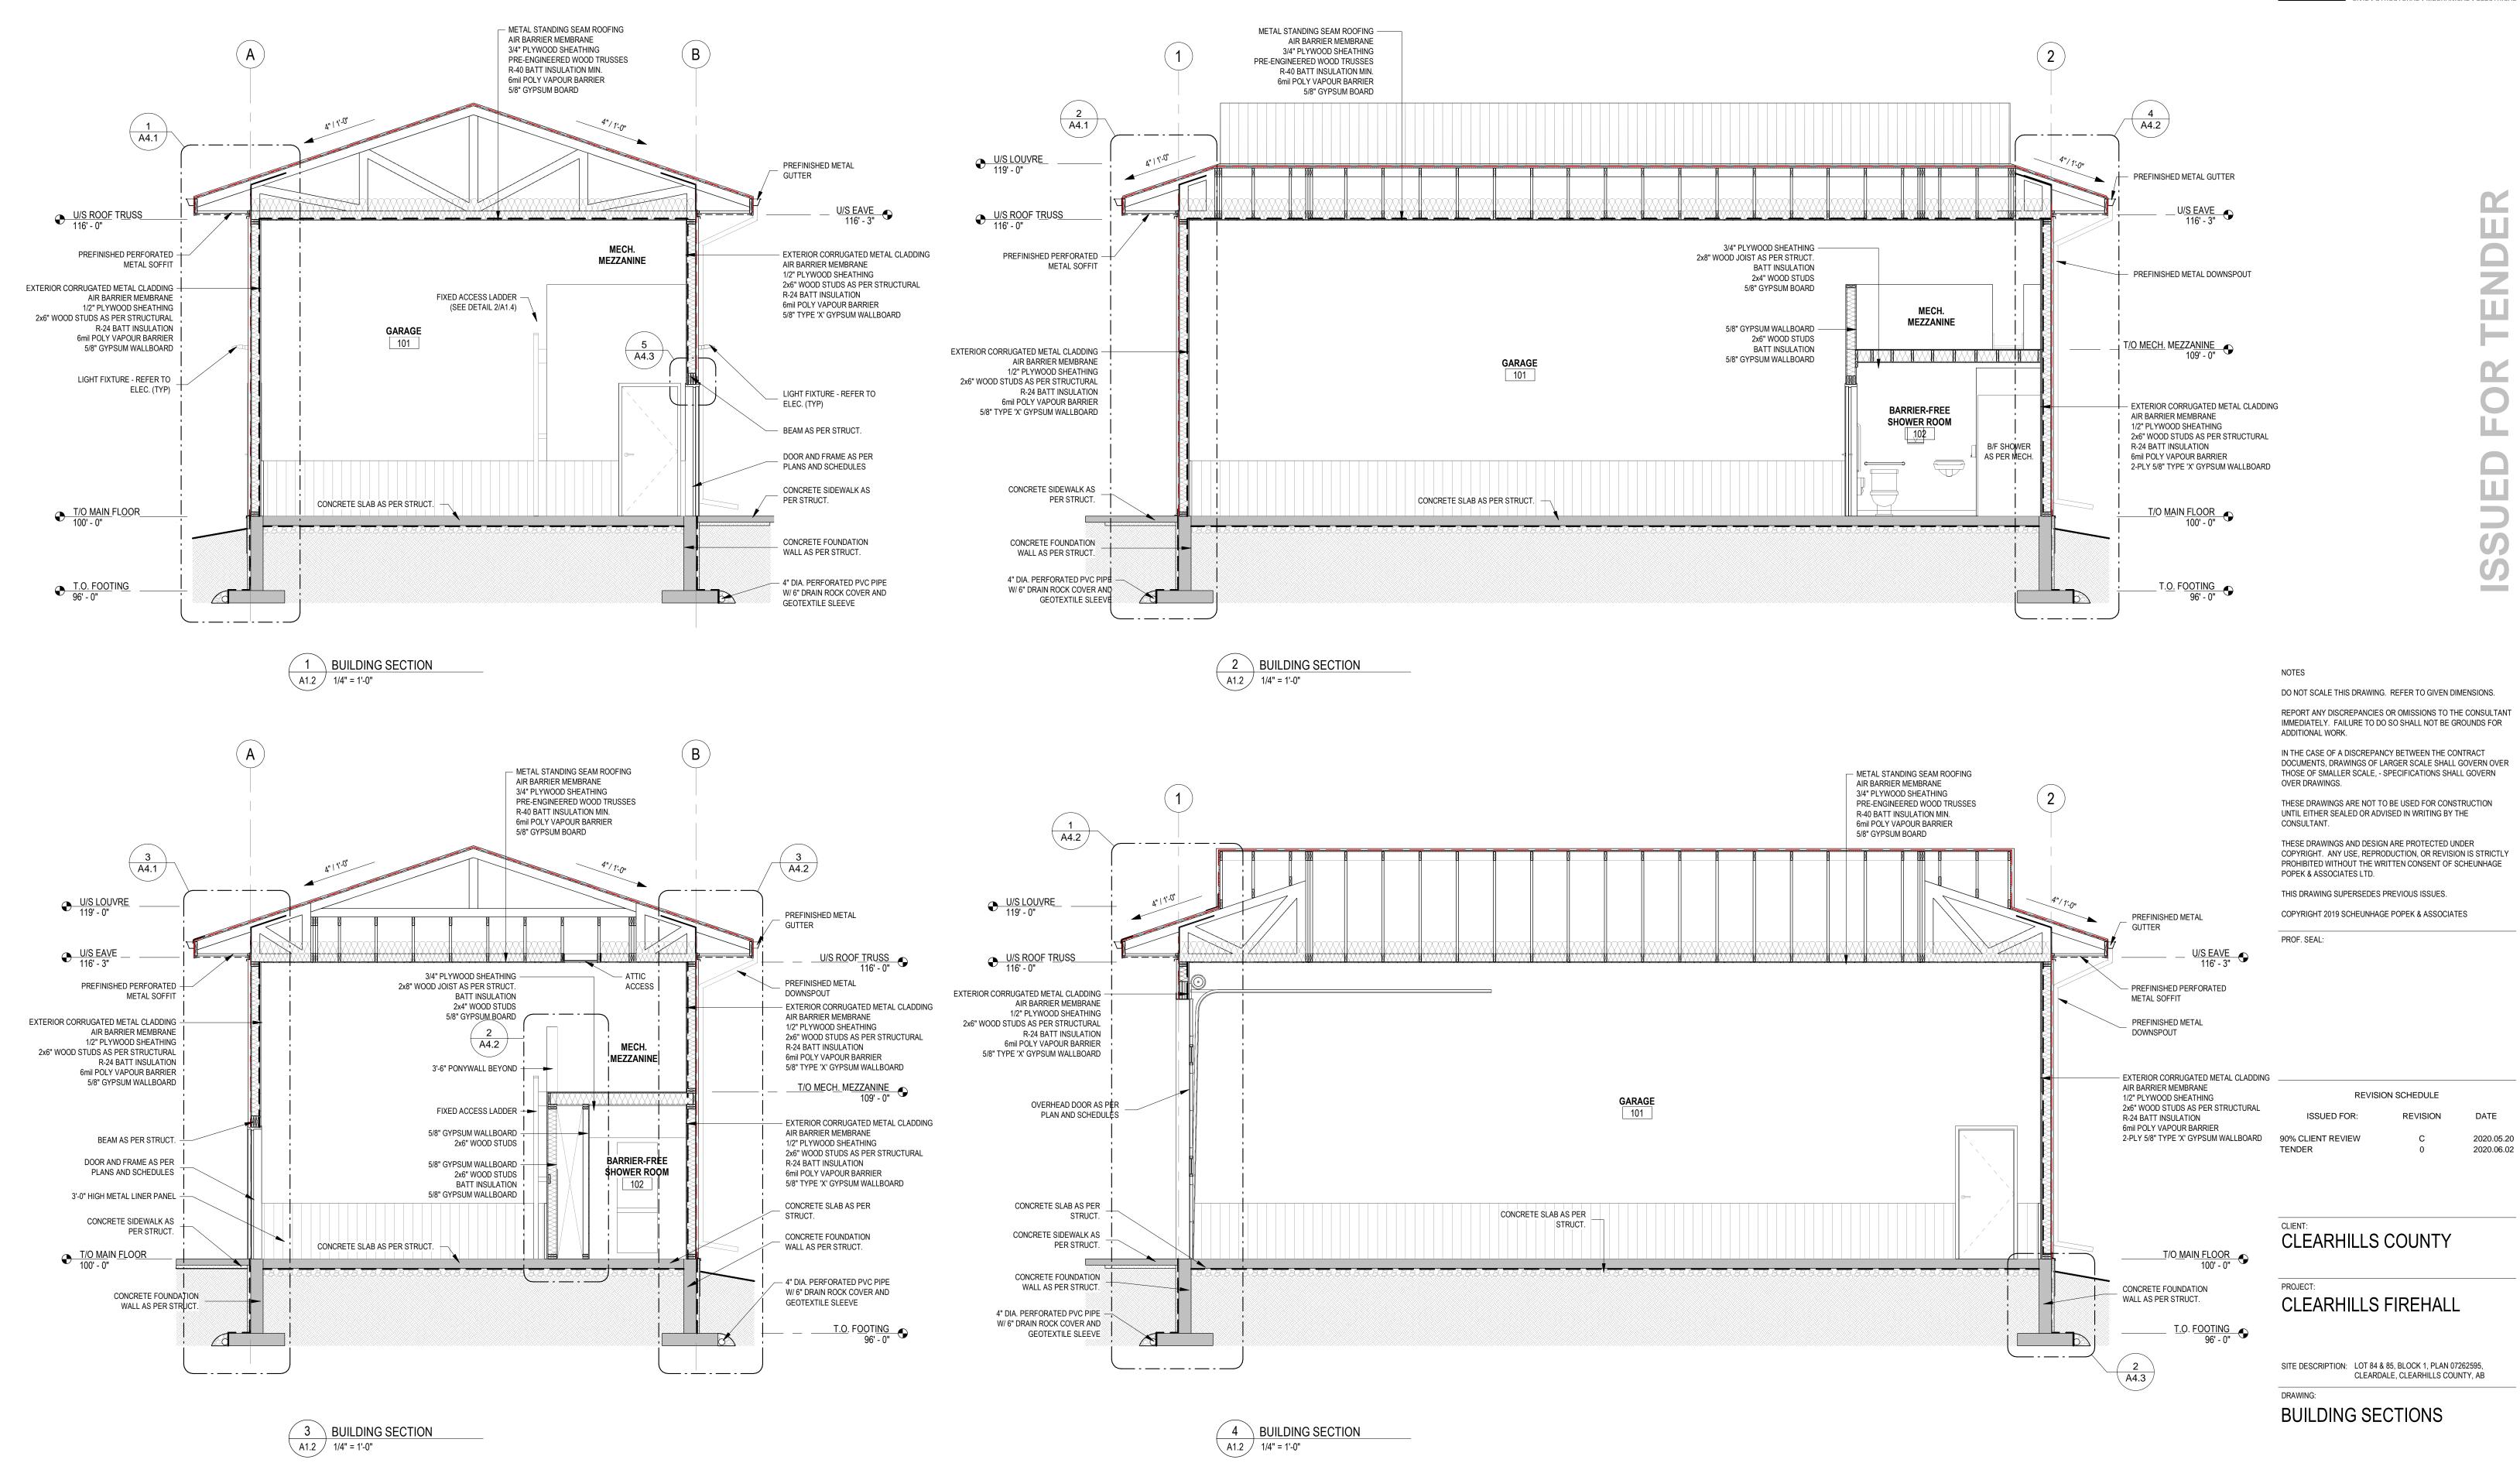
MC PROF. REVIEW:

DRAWN BY:

TECH. REVIEW:


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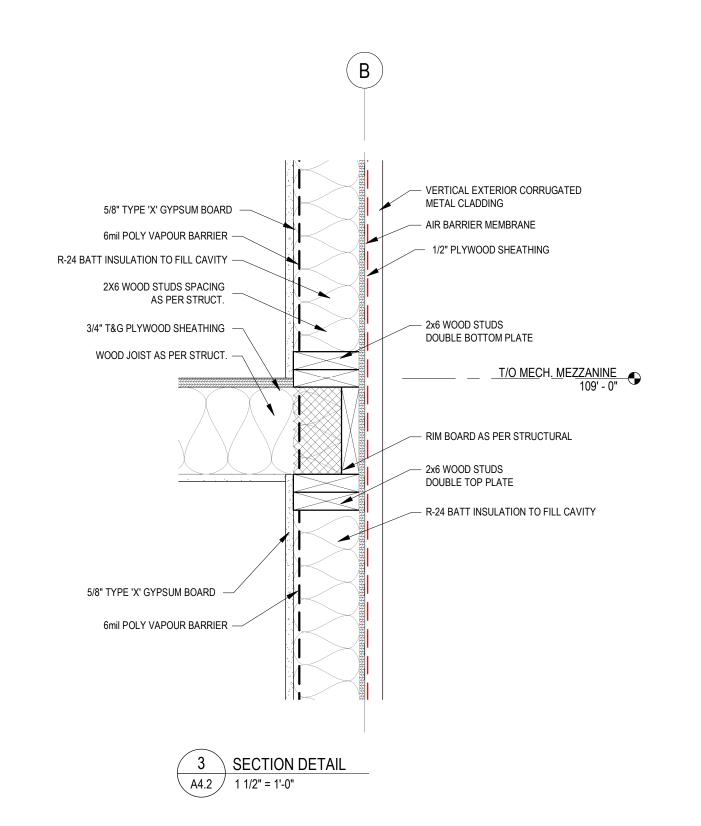


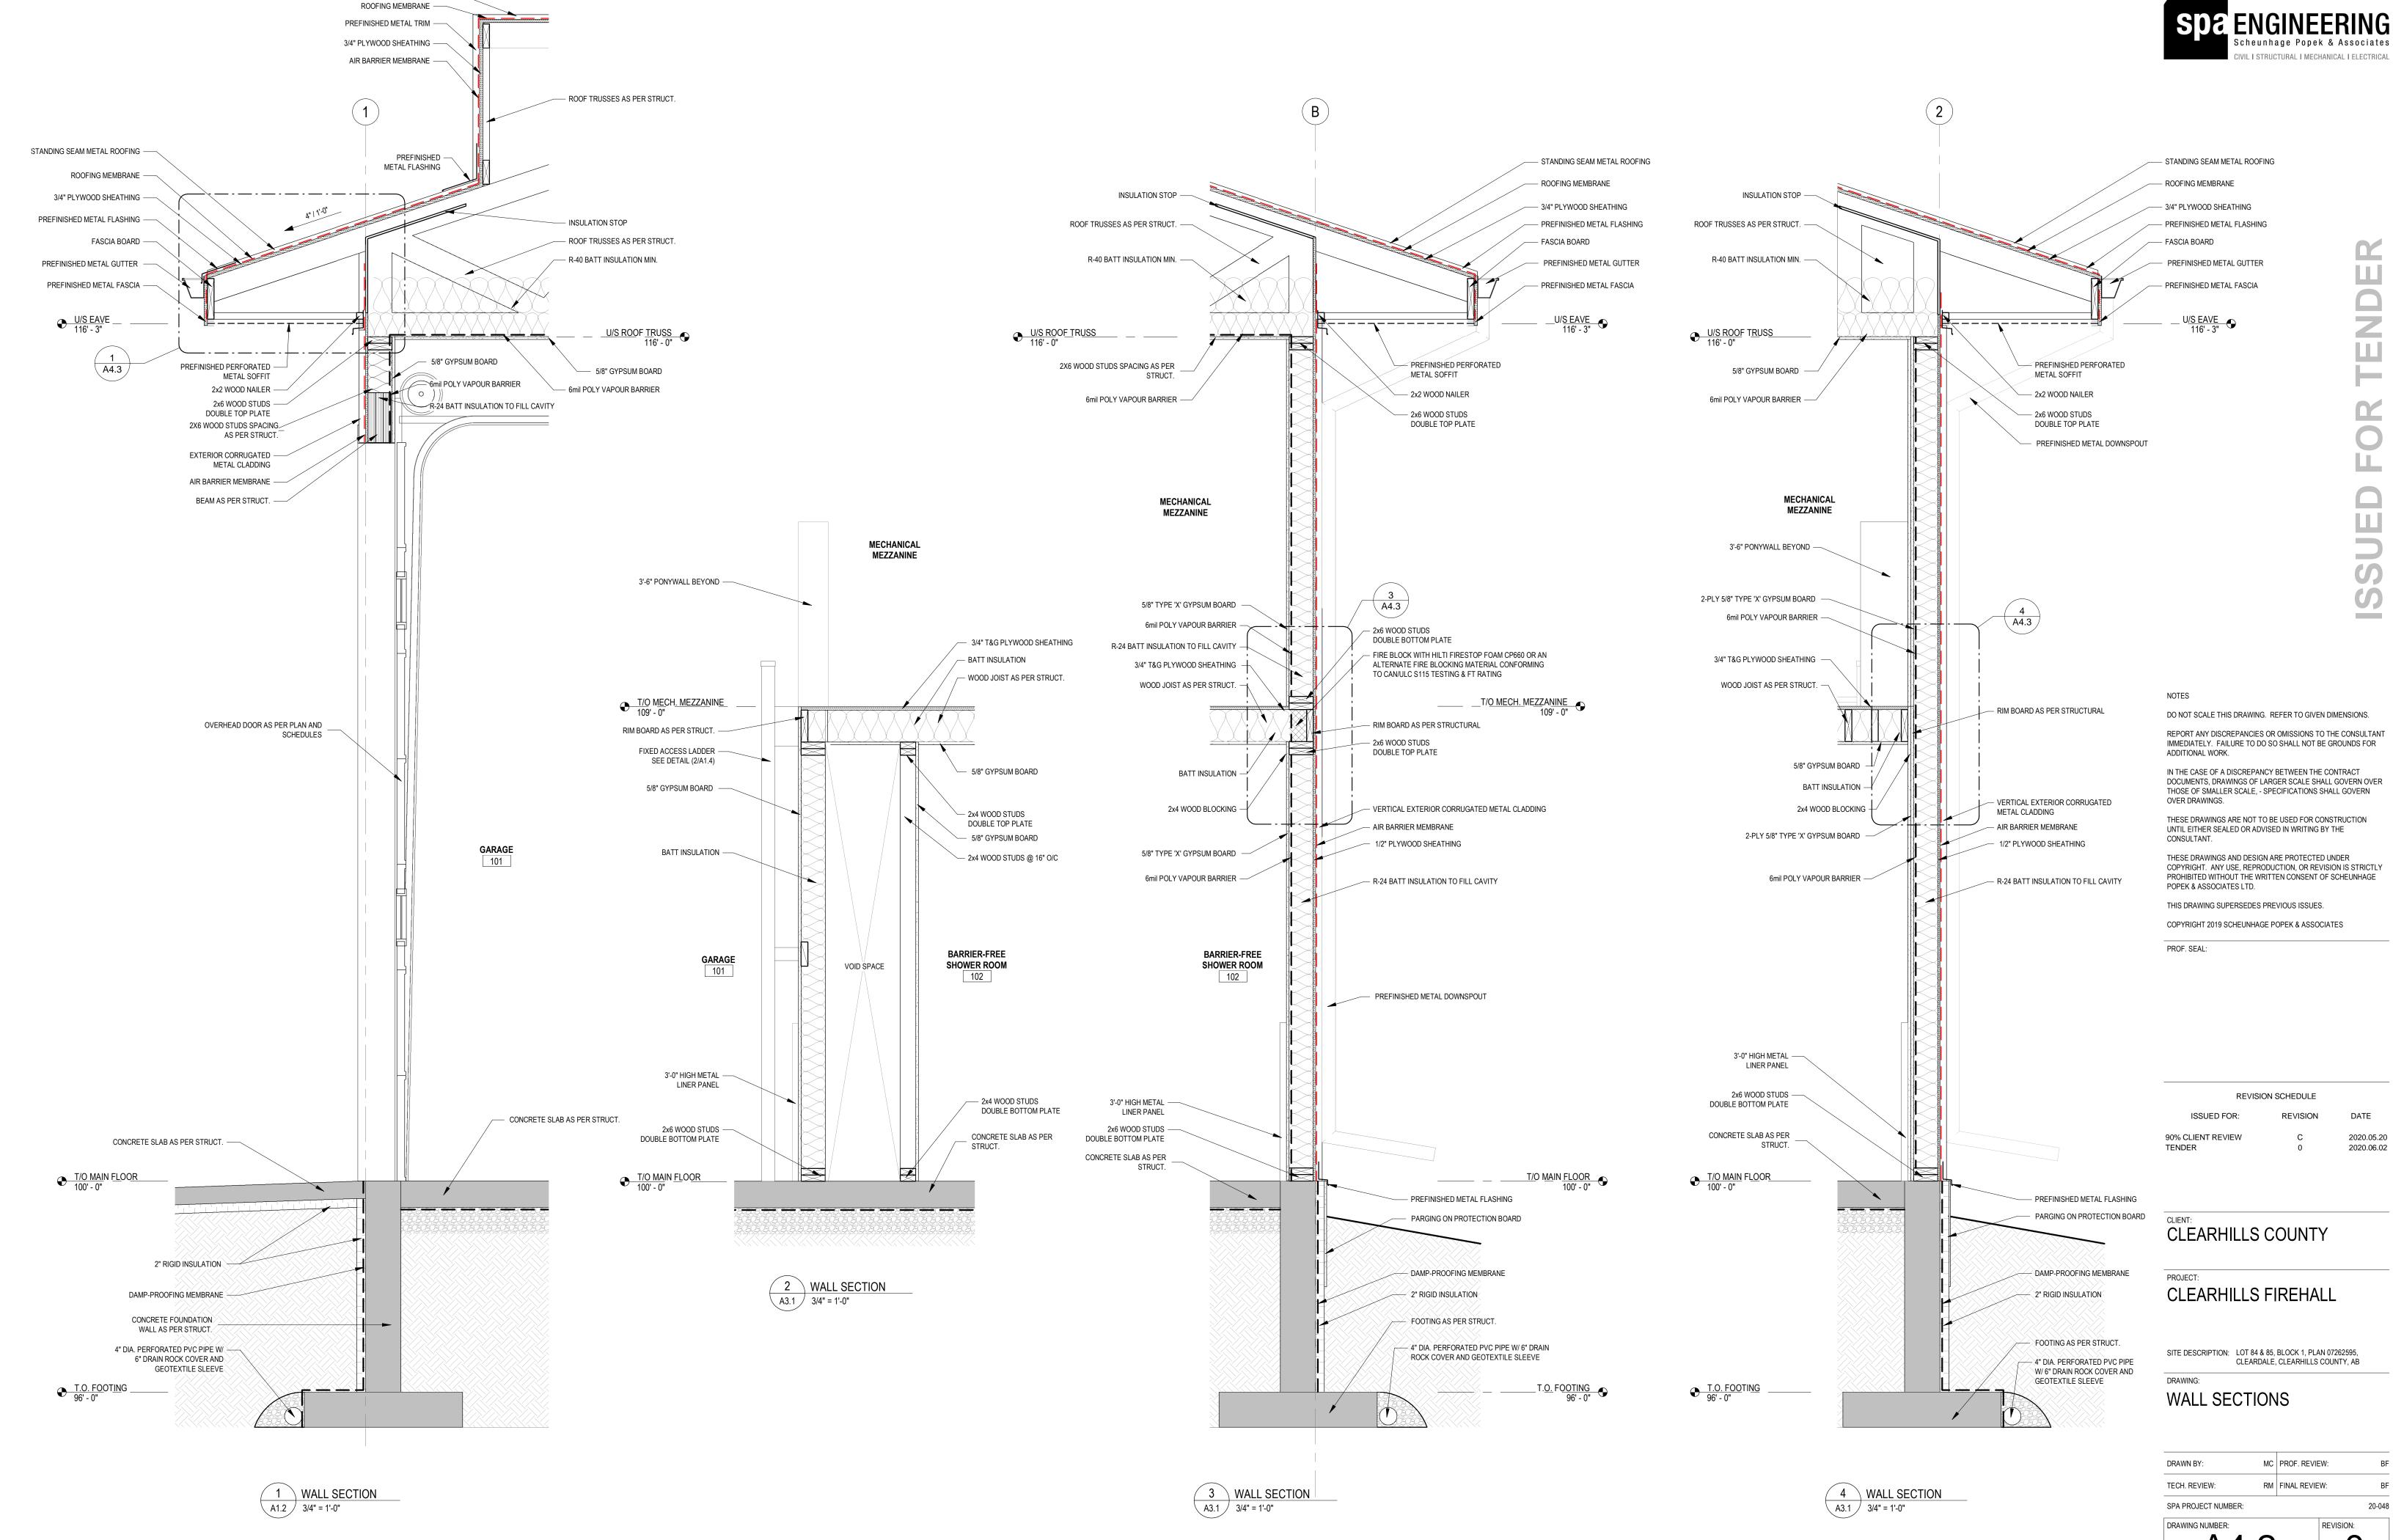



STANDING SEAM METAL ROOFING —


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NOTES

OVER DRAWINGS.

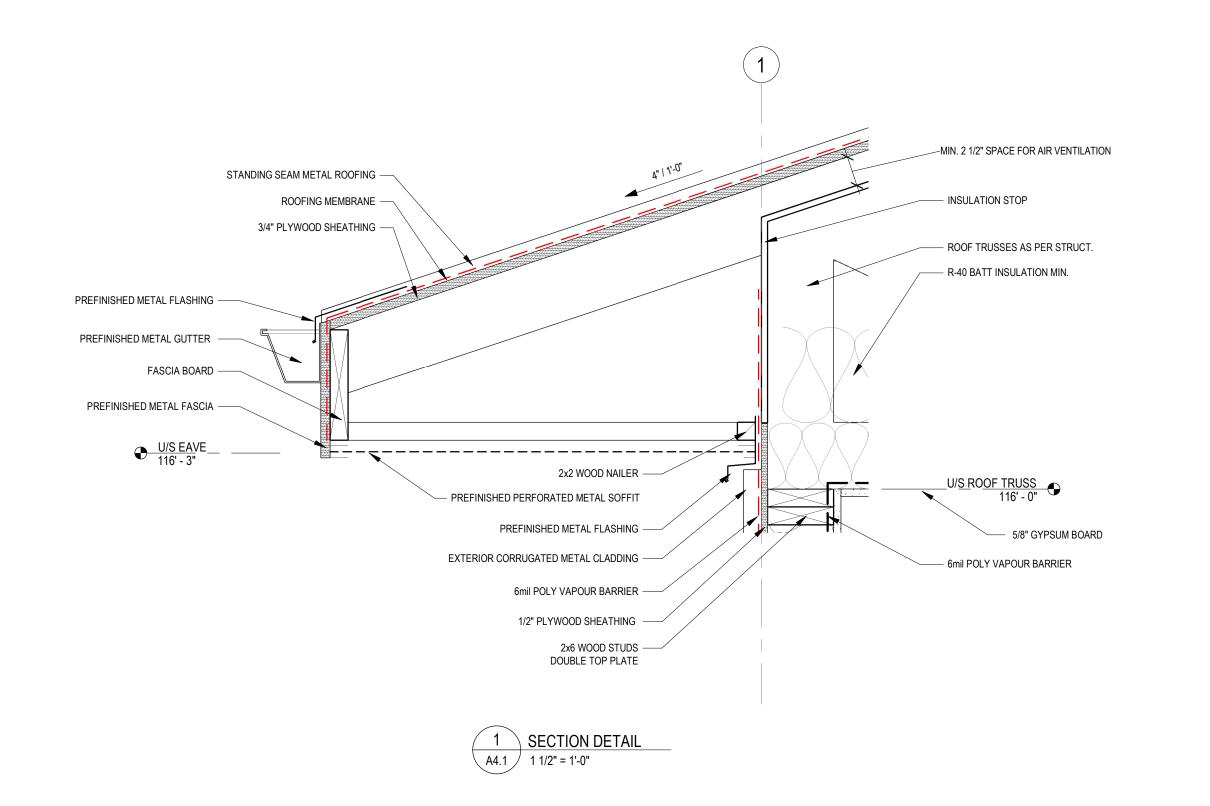CONSULTANT.
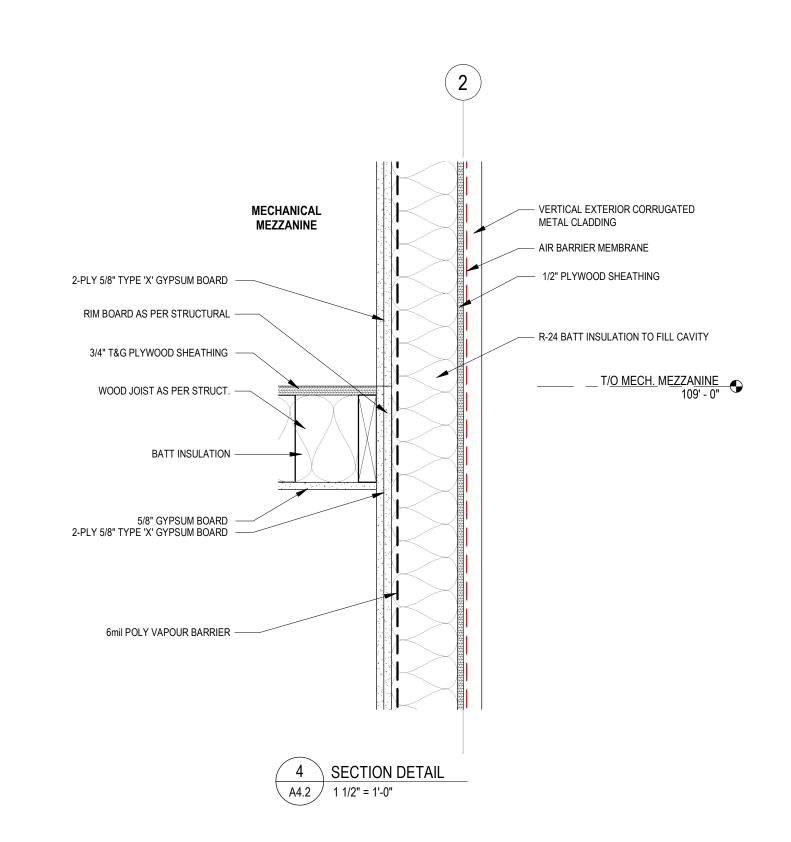
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2020.06.02

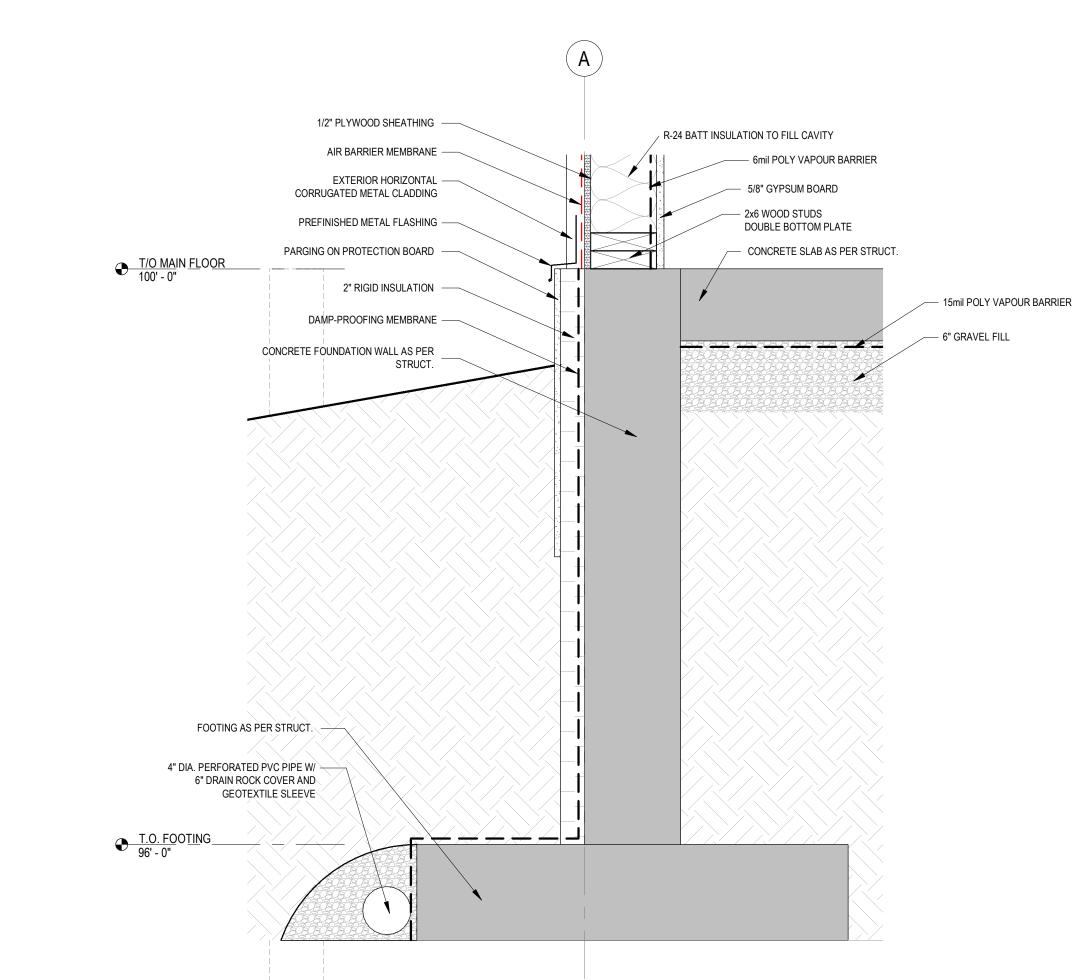CLEARHILLS COUNTY

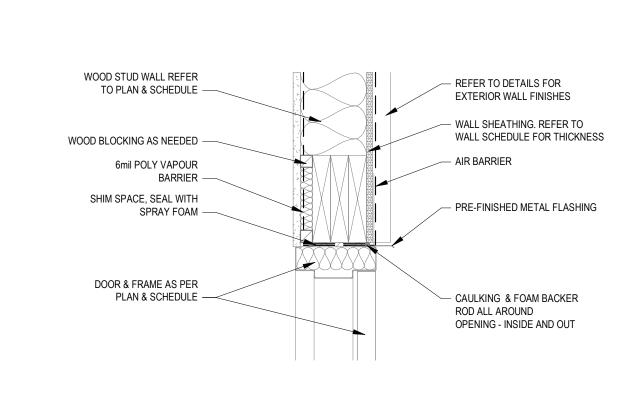CLEARHILLS FIREHALL


SITE DESCRIPTION: LOT 84 & 85, BLOCK 1, PLAN 07262595, CLEARDALE, CLEARHILLS COUNTY, AB

DETAILS

TENDER

DRAWN BY: MC PROF. REVIEW: TECH. REVIEW: RM FINAL REVIEW: SPA PROJECT NUMBER: 20-048 DRAWING NUMBER: REVISION:

ISSUED

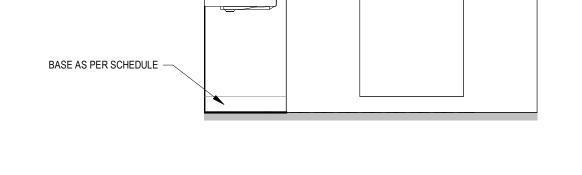


B/F SHOWER INSERT C/W GRAB BARS AND SEAT REFER TO MECH.

PAINTED GYPSUM -


WALL BOARD

BOBRICK B-2111 — SOAP DISPENSER

PLUMBING FIXTURE — AS PER MECH.

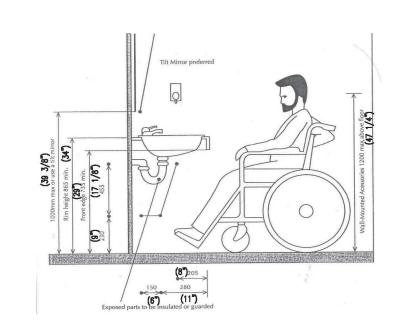

3 INTERIOR ELEVATION - B/F SHOWER ROOM
1/2" = 1'-0"

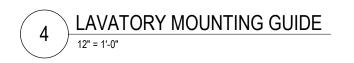



NOTES

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CLEARHILLS COUNTY


CLEARHILLS FIREHALL


SITE DESCRIPTION: LOT 84 & 85, BLOCK 1, PLAN 07262595, CLEARDALE, CLEARHILLS COUNTY, AB

INTERIOR ELEVATIONS

DRAWN BY: MC PROF. REVIEW: TECH. REVIEW: RM FINAL REVIEW: SPA PROJECT NUMBER: 20-048


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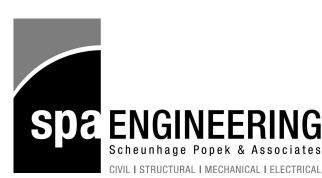


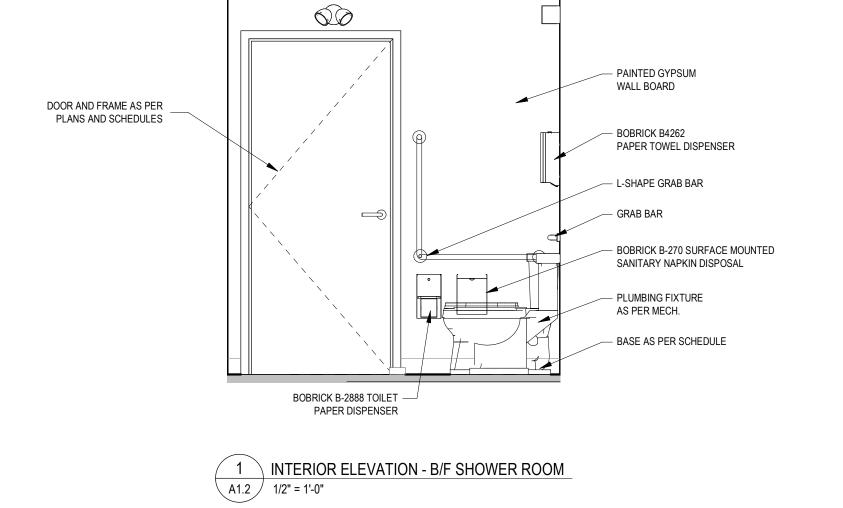		STANDARD ARCI	HITECTURAL DRAWING ABBREVIATIONS				ROOM FINISHES
ADJ	ADJUSTABLE	FD	FLOOR DRAIN	N/A	NOT APPLICABLE	СР	CARPET
AFF	ABOVE FINISHED FLOOR	FE	FIRE EXTINGUISHER	N.I.C	NOT IN CONTRACT	CPT	CARPET TILE
ALT	ALTERNATE	FEC	FIRE EXTINGUISHER CABINET	N.S	NEAR SIDE	СТ	CERAMIC TILES
ALUM.	ALUMINUM	FFE	FURNITURE FINISHES &	N.T.S	NOT TO SCALE	СТВ	CERAMIC TILE BASE
APPROX OR ±	APPROXIMATELY		EQUIPMENT	No. OR#	NUMBER		
ARCH	ARCHITECT	FLR	FLOOR			EC	EXPOSED CONCRETE
		FRR	FIRE RESISTANCE RATING	O.D	OUTSIDE DIAMETER	ECH	EXPOSED CONCRETE WITH HARDNER
BOT	BOTTOM	FRS	FIRE SHUTTER	O.F	OUTSIDE FACE		
BLK	BLOCK	FURR	FURRING	OPP	OPPOSITE	FBS	FINISH BY SUPPLIER
BLDG	BUILDING			OPNG	OPENING	FRB	FIBRE REINFORCED PANELS
		GA.	GAUGE	O/C	ON CENTRE	FSCT	FIRE RATED SUSPENDED ACOUSTIC TILE
C.L.	CENTRE LINE	GALV	GALVANIZED				
CLG.	CEILING	GL	GLASS	PERIM	PERIMETER	GCT	GLAZED CERAMIC TILES
CLR	CLEAR	GWB	GYPSUM WALL BOARD	POLY	POLYETHYLEN		
C/C	CENTRE TO CENTRE	GWB.WR	GYPSUM WALL BOARD,	PVC	POLYVINYL CHLORIDE	HD	HEAVY DUTY
C/W	COMPLETE WITH		WATER RESISTANCE				
COL	COLUMN			R	RISER	LPT	LATEX PAINT
CONC	CONCRETE	HDR	HEADER	RAD (R)	RADIUS		
CONT	CONTINUOUS	HDW	HARDWARE	REQ	REQUIRED	MLP	PREFINISHED METAL LINER PANEL
CORR	CORRIDOR	HM	HOLLOW METAL	REV	REVISION		
		HORZ	HORIZONTAL	RM	ROOM	PFF	PREP. FOR TENANT FINISH
DP	DEEP OR DEPTH	HTD	HOLD TO DIMENSION	RO	ROUGH OPENING	PLP	PLYWOOD LINER PANEL
DIA OR Ø	DIAMETER			RD	ROOF DRAIN	PO	PAINT OUT
DIAG	DIAGONAL	I.C	IN CENTRE			PS	PAINTED STRUCTURE
DIM	DIMENSION	I.D	INSIDE DIAMETER	SECT	SECTION	PA	PORCELAIN TILE
DN.	DOWN	I.F	INSIDE FACE	SIM	SIMILAR	PWB	PAINTED WOOD BASE
DF#	DOOR FINISH	INCL	INCLUDING	SPEC	SPECIFICATION		
DO OR Do	DITTO	INSUL	INSULATION	STD	STANDARD	QT	QUARRY TILES
DWG	DRAWING	INT	INTERIOR	STRUCT	STRUCTURAL		
	2.0.00			SYM	SYMMETRICAL	RB	RUBBER BASE
E.E.	EACH END	LG	LONG			1	
E.F.	EACH FACE	LOC	LOCATION	T&B	TOP & BOTTOM	sc	SEALED CONCRETE
E.J.	EXPANSION JOINT	LONGIT	LONGITUDINAL	TBD	TO BE DETERMINED	SCT	SUSPENDED ACOUSTIC CEILING TILES
E.S.	EACH SIDE			T/O	TOP OF	SF	SHEET FLOORING W/ WELDED EDGES
E.W.	EACH WAY	MAX	MAXIMUM	TYP	TYPICAL	SWB	STAINED WOOD BASE
EL OR ELEV	ELEVATION	MECH	MECHANICAL			0.12	617 III 125 176 05 57 02
ELEC	ELECTRICAL	MEZZ	MEZZANINE	UNO	UNLESS NOTED OTHERWISE	UF	UNFINISHED
EQ	EQUAL	MIN	MINIMUM	U/S	UNDERSIDE OF	UFC	UNFINISHED CONCRETE
EQ SP	EQUAL SPACES	MISC	MISCELLANEOUS	0.0		USS	UNDERSIDE OF STRUCTURE
EXIST, EXT'G OR EX.	EXISTING			VEST	VESTIBULE		5.152.15.52 5. 01110010112
EXP	EXPOSED					VT	VINYL TILE
EXPN.	EXPANSION			W/	WITH		VIIVE LIEE
EXP.S	EXPOSED STRUCTURE			WC	WATER CLOSET		
EXT.	EXTERIOR						

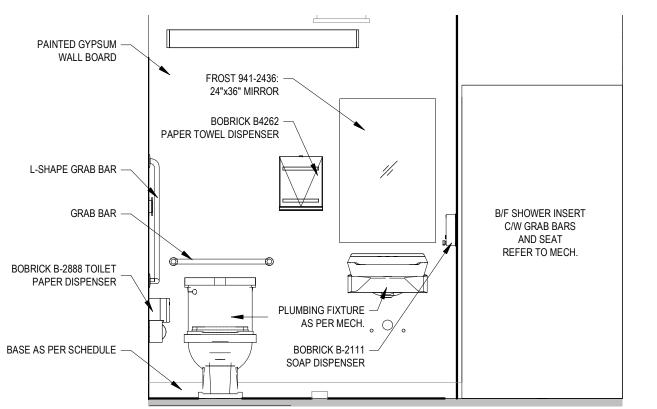

EXTERIOR WALLS	WALL DESCRIPTION	WALL DIAGRAM	INTERIOR WALLS	WALL DESCRIPTION	WALL DIAGRAM
W1	EXTERIOR CORRUGATED METAL CLADDING AIR BARRIER MEMBRANE 1/2" PLYWOOD SHEATHING 2x6" WOOD STUDS AS PER STRUCTURAL R-24 BATT INSULATION 6mil POLY VAPOUR BARRIER		P1	5/8" GYPSUM SHEATHING 2x6 WOOD STUDS @ 16" O/C R-24 BATT INSULATION 5/8" GYPSUM SHEATHING 3'-0" HIGH METAL LINER PANEL	
	5/8" GYPSUM SHEATHING 3'-0" HIGH METAL LINER PANEL		P2 PONYWALL 3'-6" ABOVE FINISHED FLOOR	5/8" GYPSUM SHEATHING 2x6 WOOD STUDS @ 16" O/C 5/8" GYPSUM SHEATHING	M
W2 • 1HR FIRE RESISTANCE RATING	EXTERIOR CORRUGATED METAL CLADDING AIR BARRIER MEMBRANE 1/2" PLYWOOD SHEATHING 2x6" WOOD STUDS AS PER STRUCTURAL R-24 BATT INSULATION 6mil POLY VAPOUR BARRIER 5/8" TYPE 'X' GYPSUM SHEATHING		P3	5/8" GYPSUM SHEATHING 2x4 WOOD STUDS @ 16" O/C	<u> </u>
W3 • 1HR FIRE RESISTANCE RATING	3'-0" HIGH METAL LINER PANEL EXTERIOR CORRUGATED METAL CLADDING AIR BARRIER MEMBRANE 1/2" PLYWOOD SHEATHING 2x6" WOOD STUDS AS PER STRUCTURAL R-24 BATT INSULATION 6mil POLY VAPOUR BARRIER 5/8" TYPE 'X' GYPSUM SHEATHING		AND FACADES ARE CONSTRUCTED OR INSTA WITH NRC CNRC CONSTRUCTION TECHNOLO INSTALLATION PROCEDURES SHALL BE SUB DOES NOT APPROVE, WARRANTEE OR GUAF COMPONENT THAT DOES NOT MAINTAIN RAI	A MAXIMIUM 13'-0" (4m) O.C. HORIZONTAL AND VERTICAL FOR ALL EXTERIOR FINIS	
W4 • 2HR FIRE RESISTANCE RATING	EXTERIOR CORRUGATED METAL CLADDING AIR BARRIER MEMBRANE 1/2" PLYWOOD SHEATHING 2x6" WOOD STUDS AS PER STRUCTURAL R-24 BATT INSULATION 6mil POLY VAPOUR BARRIER 2-PLY 5/8" TYPE 'X' GYPSUM SHEATHING 3'-0" HIGH METAL LINER PANEL				
W5 • 2HR FIRE RESISTANCE RATING	EXTERIOR CORRUGATED METAL CLADDING AIR BARRIER MEMBRANE 1/2" PLYWOOD SHEATHING 2x6" WOOD STUDS AS PER STRUCTURAL R-24 BATT INSULATION 6mil POLY VAPOUR BARRIER 2-PLY 5/8" TYPE 'X' GYPSUM SHEATHING				

ROOM FINISH SCHEDULE										
				Wall Finish						
Room Number	Room Name	Floor Finish	Base Finish	North	East	South	West	Ceiling Finish	Ceiling Height	Comments
101	GARAGE	SC	MLP	LPT	LPT	LPT	LPT	LPT	15' - 11 3/8"	3'-0" HIGH MLP ABOVE FINISHED MAIN FLOOR
100	DADDIED EDEE CHOWED DOOM	90	DD	LDT	LDT	I DT	I DT	I DT	7' 11 7/Q"	

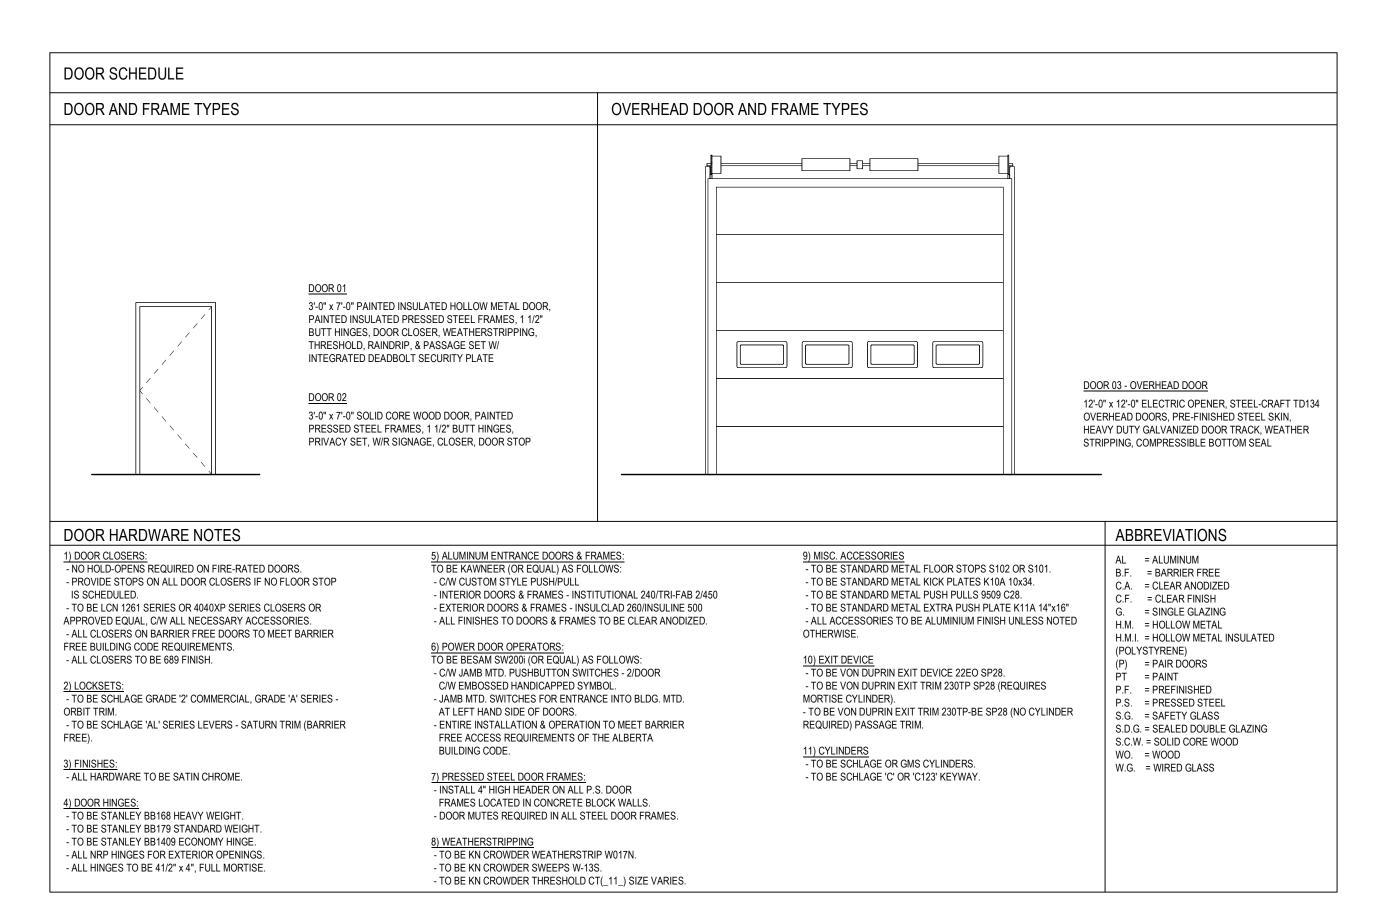

TENDER

ISSUE

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CLEARHILLS COUNTY

PROJECT:

CLEARHILLS FIREHALL

SITE DESCRIPTION: LOT 84 & 85, BLOCK 1, PLAN 07262595, CLEARDALE, CLEARHILLS COUNTY, AB

SCHEDULES

DRAWN BY: MC PROF. REVIEW: BF

TECH. REVIEW: RM FINAL REVIEW: BF

SPA PROJECT NUMBER: 20-048

DRAWING NUMBER:

DESIGN LOADS - CLEARDALE, AB

- ALL LOADS OUTLINED IN ALBERTA BUILDING CODE 2019 UNLESS NOTED OTHERWISE SPECIFIED LOADS ARE SHOWN:
- 1. BUILDING IMPORTANCE CATEGORY = POST DISASTER BUILDING IMPORTANCE FACTOR (Is)1.25(ULS) 0.9(SLS)
- (lw)1.25(ULS) 0.75(SLS)
- 2. LATERAL LOADS FROM WIND AND SEISMIC FOR WIND LOADS:
- REFERENCE VELOCITY PRESSURE (a 1/10) REFERENCE VELOCITY PRESSURE (q 1/50) 0.35 kPa FOR SEISMIC LOADS: Sa (1.0)
- LATERAL LOADS FROM WIND AND SEISMIC ARE RESISTED BY STEEL BRACING

3. SF	PECIFIED IMPOSED LOADS FOR FLOOR AND ROOF D	ESIGN (UNLESS SHOWN OTHERWISE
Ol	N PLANS)	
•	ROOF LOADS:	
	SNOW	2.53 kPa + DRIFT
	RAIN	0.10 kPa
	ONE DAY RAIN (24 HOURS)	86mm

- 4. CLIMATE LOADS FROM SNOW
- FOR SNOW LOADS:

Ss (1/50)

Sr (1/50)

GENERAL STRUCTURAL NOTES

I. READ STRUCTURAL DRAWINGS IN CONJUNCTION WITH THE ARCHITECTURAL, MECHANICAL, ELECTRICAL DRAWINGS, SPECIFICATIONS AND OTHER CONTRACT DOCUMENTS FOR DETAILED DIMENSIONS OF DOORS, WINDOWS, DUCTS, OPENINGS, REBATES, CHASERS.

0.1kPa

- 2. CHECK AND VERIFY ALL DIMENSIONS WITH THE ARCHITECTURAL DRAWINGS BEFORE COMMENCING ANY WORK. NOTIFY THE ARCHITECT OF ANY ERRORS OR OMISSIONS.
- 3. DRAWINGS SHOW COMPLETED STRUCTURES ONLY, TEMPORARY BRACING FOR CONSTRUCTION LOADING CONDITIONS IS THE RESPONSIBILITY OF ITS CONTRACTOR.
- 4. DO NOT CONSTRUCT FROM THESE DRAWINGS UNLESS MARKED "ISSUED FOR CONSTRUCTION"

SUBMISSIONS AND INSPECTIONS

- 1. ALL REQUIRED SHOP DRAWINGS SHALL BE SUBMITTED FOR REVIEW PRIOR TO START OF FABRICATION. SHOP DRAWINGS REQUIRING PROFESSIONAL ENGINEER'S SEAL WILL NOT BE ACCEPTED WITHOUT IT.
- 2. NOTIFY THE ENGINEER 48 HOURS IN ADVANCE FOR INSPECTION AND APPROVAL OF THE

 CONCRETE REINFORCEMENT WOOD FRAMING

BEFORE COVERING UP SCHEUNHAGE POPEK & ASSOCIATES LTD. WILL REVIEW SHOP DRAWINGS PERTAINING TO WORK SHOWN ON SCHEUNHAGE POPEK'S DRAWINGS. THE EXTENT OF THIS REVIEW IS AT THE SOLE DISCRETION OF SCHEUNHAGE POPEK'S ENGINEER AND IS FOR THE SOLE PURPOSE OF ASCERTAINING GENERAL CONFORMANCE WITH THE STRUCTURAL DESIGN CONCEPT. THE REVIEW IS NOT AN APPROVAL OF THE DESIGN. DETAILS AND DIMENSIONS INHERENT IN THE

CONTRACTORS SUBMITTING THEM. SUCH REVIEW SHALL NOT RELIEVE THE CONTRACTOR OF


THEIR RESPONSIBILITY FOR ERRORS AND OMISSIONS IN THE SHOP DRAWINGS OR FOR

MEETING ALL REQUIREMENTS OF THE CONTRACT DOCUMENTS.

- 1. A GEOTECHNICAL INVESTIGATION TO BE CONDUCTED BY A PROFESSIONAL GEOTECNICAL ENGINEER AND REPORT ISSUED TO CONSULTIN ENGINEER PRIOR TO FOUNDATION WORK
- 2. THE GEOTECHNICAL ENGINEER OF RECORD SHALL AFTER EXCAVATION REVIEW ALL BEARING SOIL CONDITIONS PRIOR TO PLACEMENT OF FOUNDATIONS. TO ENSURE ADEQUATE SOIL MATERIAL AND BEARING CAPACITY IS PROVIDED FOR THE FOUNDATIONS AS INDICATED ON THE CONSTRUCTION DOCUMENTS
- 3. THE GEOTECHNICAL ENGINEER SHALL PROVIDE LETTERS OF ASSURANCE TO THE COORDINATING PROFESSIONAL AS PER THE REQUIREMENTS OF THE CURRENT PROVINCIAL BUILDING CODE

4. FOOTING FOUNDATION NOTES:

- CAST-IN-PLACE CONCRETE STRIP FOOTINGS HAVE BEEN DESIGNED ON THE BASIS OF AN ALLOWABLE BEARING PRESSURE OF 90 kPa
- FOOTING SHALL BE PLACED AT A MINIMUM DEPTH OF 4'-0" OR AS REQUIRED BY THE GEOTECHNICAL ENGINEER OF RECORD UNLESS SHOWN OTHERWISE, CENTER FOOTINGS UNDER WALLS OR PIERS.
- 5. LATERAL SOIL PRESSURE ON WALLS INCLUDING SURCHARGE SHALL BE AS FOLLOWS. UNLESS NOTED IN THE GEOTECHNICAL REPORT:

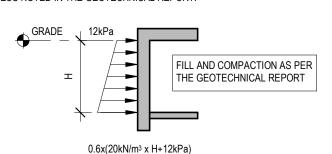

NON-STRUCTURAL ELEMENTS

- 1. "NON-STRUCTURAL" OR "SECONDARY STRUCTURAL" ELEMENTS ARE NOT THE RESPONSIBILITY OF SCHEUNHAGE POPEK & ASSOCIATES LTD. WHERE STRUCTURAL ENGINEERING RESPONSIBILITY IS REQUIRED FOR THESE ELEMENTS. THIS SHALL BE PROVIDED BY THE SPECIALTY STRUCTURAL ENGINEERS, WHO SHALL ALSO PROVIDE ANY LETTERS REQUIRED BY THE BUILDING PERMIT AUTHORITIES
- 2. EXAMPLES OF NON STRUCTURAL ELEMENTS INCLUDE, BUT ATE NOT LIMITED TO: ARCHITECTURAL COMPONENTS SUCH AS GUARDRAILS, HANDRAILS, FLAG POSTS,
- CANOPIES, CEILINGS, MILLWORK, ETC. • LANDSCAPE ELEMENTS SUCH AS BENCHES, LIGHT POSTS, PLANTERS, ETC.
- CLADDING, GLAZING, WINDOW MULLIONS, INTERIOR, AND EXTERIOR STUD WALLS. ARCHITECTURAL PRECAST, PRECAST CLADDING. SKYLIGHTS
- MECHANICAL AND ELECTRICAL EQUIPMENT, COMPONENTS AND THEIR ATTACHMENT DETAILS
- WINDOW WASHING EQUIPMENT AND IT'S ATTACHMENTS ESCALATORS, ELEVATORS AND CONVEYING SYSTEMS
- BRICK OR BLOCK VENEERS AND THEIR ATTACHMENTS
- NON-LOAD BEARING MASONRY NON-STRUCTURAL CONCRETE TOPPING

- 1. DESIGN SHALL BE BASED ON THE CRITERIA RECOMMENDED IN THE SOILS REPORT AND SHALL BE TO THE APPROVAL OF THE AUTHORITY HAVING JURISDICTION.
- 2. WHERE REQUIRED, SHORING CONTRACTOR TO OBTAIN ALL NECESSARY APPROVALS FOR INSTALLATION OF TIE-BACK ANCHORS. CONTRACTOR SHALL ESTABLISH THE LOCATION AND EXTENT TO UNDERGROUND UTILITY LINES WHERE INTERFERENCE WITH EXCAVATION/SHORING OPERATIONS ARE POSSIBLE TO OCCUR.
- 3. EXAMINE SITE PLAN FOR EXISTING GRADE ELEVATIONS. CONTRACTOR TO DETERMINE EXTENT OF SHORING REQUIRED, AND SURCHARGE REQUIREMENTS FROM SITE CONDITIONS, DESIGN FOR A MINIMUM OF 10.0 kPa SURCHARGE
- 4. SOLDIER PILE LOCATIONS TO BE APPROVED BY THE STRUCTURAL ENGINEER FOR MINIMUM INTERFERENCE TO COLUMNS, WALLS AND REINFORCEMENT. MAKE PROVISIONS IN ALL EMBEDDED PLATES TO ALLOW THE CONTINUITY OF WALL REINFORCING

CONCRETE FOUNDATIONS

- 1. CONCRETE DESIGN IS BASED ON THE FOUNDATIONS INVESTIGATION SOILS REPORT PREPARED BY GEOTECHNICAL ENGINEER. REFER TO THE REPORT FOR ANY PARTICULARS AS TO SOIL CONDITIONS AND FOUNDATION RECOMMENDATIONS.
- 2. ENSURE THAT THE REQUIREMENTS OUTLINED IN THIS REPORT ARE READ AND UNDERSTOOD PRIOR TO COMMENCING WITH FOUNDATION WORK.
- 3. PRIOR TO PLACING CONCRETE FOR FOUNDATIONS, BEARING STRATA SHALL BE INSPECTED BY A GEOTECHNICAL CONSULTANT TO CONFIRM BEARING STRATA. SCHEUNHAGE POPEK & ASSOCIATES LTD. IS NOT RESPONSIBLE FOR CONFIRMING FOUNDATION CAPACITIES OF
- 4. UNLESS OTHERWISE SHOWN, CENTRE FOUNDATIONS UNDER COLUMNS AND WALLS.
- 5. TIE ALL DOWELS AND ANCHOR BOLTS IN PLACE BEFORE POURING CONCRETE. USE TEMPLATES TO ENSURE CORRECT PLACEMENT.
- 6. ALL BACKFILL MATERIALS AND BACKFILL INSTALLATION SHALL BE REVIEWED BY A GEOTECHNICAL ENGINEER TO ENSURE COMPLIANCE TO THE RECOMMENDATIONS AS
- 7. SEE ARCHITECTURAL DRAWINGS AND SPECIFICATIONS FOR DAMP PROOFING OR WATER
- 8. FOR GROUND ELEVATIONS AND DRAINAGE SLOPES, SEE ARCHITECTURAL DRAWINGS.

1. CONCRETE TO CONFORM TO CSA-A23.1.

NOTED IN THE GEOTECHNICAL REPORT.

- 2. USE TYPE GU (GENERAL USE) PORTLAND CEMENT FOR CONCRETE, EXCEPT WHERE IN CONTACT WITH SOIL, USE TYPE HS (HIGH SULPHATE) RESISTANT CEMENT
- 3. CONCRETE TO MEET THE FOLLOWING REQUIREMENTS:

	CONCRETE SCHEDULE							
EXPOSURE CLASS	ELEMENT	CEMENT TYPE	MIN. STRNGTH	SLUMP	MAX. AGG. SIZE	W/C RATIO	AIR Entrainmen	
S-2	PILES, FOOTINGS, PILE CAPS, PIERS, FOUNDATION WALLS, RETAINING WALLS & GRADE BEAMS	HS	32 MPa @ 28 DAYS	3" (80mm)	3/4" (20mm)	0.45	4% - 7%	
N	INTERIOR COLUMN, INTERIOR WALLS, STRUCTURAL SLABS	GU	30 MPa @ 28 DAYS	2 1/2" (80mm)	3/4" (20mm)	0.50	NOT REQUIRED	
N	SLAB ON GRADE	GU	25 MPa @ 28 DAYS	3" (80mm)	3/4" (20mm)	0.55	NOT REQUIRED	
F-1	STOOPS (STRUCTURAL & ON GRADE)	GU	30 MPa @ 28 DAYS	3" (80mm)	3/4" (20mm)	0.50	5% - 8%	
C-1	PARKING SLABS, PARKING RAMPS & CONCRETE APRONS	GU	35 MPa @ 28 DAYS	2 1/2" (80mm)	3/4" (20mm)	0.40	5% - 8%	
C-1	SIDEWALKS, CURBS & GUTTERS, SPLASH PAD, SUMP PITS	GU	35 MPa @ 28 DAYS	3" (80mm)	3/4" (20mm)	0.40	5% - 8%	
N	INTERIOR ENCASING FOR ELECT. DUCT BANKS & CONDUITS & MECH. DUCTS	GU	30 MPa @ 28 DAYS	2 1/2" (80mm)	3/4" (20mm)	0.50	NOT REQUIRED	
S-2	UNDERGROUND ENCASING FOR ELECT. DUCT BANKS & CONDUITS & MECH. DUCTS	HS	32 MPa @ 56 DAYS	3" (80mm)	3/4" (20mm)	0.50	4% - 7%	
N	CONCRETE TOPPING OF INTERIOR FLOOR DECKS	GU	25 MPa @ 28 DAYS	3" (80mm)	3/8" (10mm)	0.55	NOT REQUIRED	

- 4. FLY ASH CONTENT SHALL NOT EXCEED 22% OF TOTAL CEMENTITIOUS MATERIALS.
- 5. ADMIXTURES CONTAINING CALCIUM CHLORIDE ARE NOT PERMITTED.
- 6. SUPERPLASTICIZING ADMIXTURE IS PERMITTED TO ALLOW PUMPING OR IMPROVE SURFACE
- 7. FOR FLOOR SLABS, DESIGN THE CONCRETE MIXTURE WITH AGGREGATE GRADING AND WATER-TO CEMENTING MATERIALS RATIO THAT MINIMIZE SHRINKAGE.
- 8. REJECT ALL CONCRETE WHEN TIME BETWEEN BATCHING AND PLACING EXCEEDS 2 HOURS.
- 9. DO NOT ADD WATER TO THE CONCRETE ON SITE UNLESS AUTHORIZED BY THE CONCRETE
- 10. PROTECT CONCRETE FROM ADVERSE WEATHER CONDITIONS IN ACCORDANCE WITH CSA-
- 11. FOR TYPE HS & MS CONCRETE PROVIDE MINIMUM 20 MPa @ 28 DAYS.

CAST-IN-PLACE CONCRETE

- 1. CONCRETE MATERIAL, QUALITY, MIXING, PLACING, FORMWORK AND OTHER CONSTRUCTION PRACTICES TO CONFORM TO CSA-A23.1-04
- 2. TO ENSURE THAT THE REQUIRED CONCRETE STRENGTHS ARE BEING ACHIEVED, CONCRETE TESTS SHALL BE PERFORMED BY A RECOGNIZED TESTING LABORATORY IN ACCORDANCE WITH CSA-A23.2-04.
- 3. SUBMIT PROPOSED MIX DESIGN TO BE REVIEWED BY AN AGENCY APPROVED BY AND RESPONSIBLE TO THE SUB-CONSULTANT AND PAID FOR BY THE OWNER, PRIOR TO
- 4. REINFORCEMENT SHALL BE CHAIRED OFF THE SUB GRADE PRIOR TO PLACING CONCRETE. 5. SLAB POURS SHALL NOT EXCEED 45'-0" (14m).

6. SEAL ALL JOINTS AND LAPS.

FLOOR SLAB. IT IS IMPERATIVE THAT THE SUBSOIL MOISTURE CONTENT REMAINS STABLE. IN SOILS OF THIS NATURE, A STRUCTURAL SLAB IS RECOMMENDED TO AVOID FLOOR CRACKING. SETTLEMENT AND HEAVING.

7 DUE TO EXPANDING CLAY SUBSOIL HEAVING OF THE CLAY SUBSOIL MAY OCCUR WITH

INCREASES WITH THE SOIL MOISTURE CONTENT. WHICH WILL RESULT IN CRACKING OF THE

- IT IS THE OPINION OF SCHEUNHAGE POPEK & ASSOCIATES LTD. THAT GRADE SUPPORTED SLABS SHOULD NOT BE PLACED ON CLAY MATERIAL OR AREAS CONTAINING PROBLEM SOILS OR FROST. A STRUCTURALLY SUPPORTED SLAB IS STRONGLY RECOMMENDED FOR THESE CONDITIONS.
- 9. CONCRETE WORK TO BE WITHIN THE TOLERANCES LISTED BELOW: VARIATION OF THE LINEAR BUILDING LINES LESS THAN 3/16" (5mm) VARIATION OF THE GROSS SECTIONS OF THICKNESS OF SLABS ± 1/4" (±6mm² · VARIATION FROM LEVEL OR FROM GRADES INDICATED FOR SURFACES OF SLAB SHALL NOT EXCEED 3/16" (3mm) UNDER STRAIGHT EDGE IMMEDIATELY AFTER TROWELING
- 10. LAYOUT CONSTRUCTION JOINTS PRIOR TO PLACEMENT OF CONCRETE.
- 11. PROVIDE ADEQUATE COLD WEATHER PROTECTION WHEN PLACING CONCRETE IN INCLEMENT WEATHER CONDITIONS

CONCRETE FORMWORK

- 1. CONCRETE FORMWORK SHALL CONFORM WITH: THE LATEST PROVINCIAL BUILDING CODE CAN/CSA-269.1-1975 (R2003)
- 2. THE DESIGN OF CONCRETE FORMWORK AND ADEQUATE SHORING SYSTEMS IS THE RESPONSIBILITY OF THE CONTRACTOR.
- 3. ALL FORMWORK SHALL REMAIN IN PLACE UNTIL CONCRETE HAS GAINED SUFFICIENT STRENGTH TO PREVENT DAMAGE TO THE CONCRETE, DANGER TO WORKERS, AND EXCESSIVE CREEP DEFLECTION IN THE CASE OF A STRUCTURAL SLAB AND BEAM. THE FORMWORK SHALL REMAIN IN PLACE FOR A MINIMUM OF 14 DAYS. IF THE SLAB IS RESHORED, THE FORMWORK MAY BE REMOVED AFTER A MINIMUM OF 4 DAYS. RESHORING SHALL PROCEED IN UNISON WITH STRIPPING. UNSUPPORTED AREAS SHALL NOT EXCEED 20 sq ft (2m2) RESHORING SHALL BE DESIGNED AND SEALED BY THE FORMWORK SUPPLIER'S PROFESSIONAL ENGINEER. UNSUPPORTED SLABS SHALL NOT BE LOADED WITH LIVE LOADS OR CONSTRUCTION LOADS FOR A MINIMUM OF 28 DAYS.
- 4. CONSTRUCT FORMWORK TO MAINTAIN THE FOLLOWING MAXIMUM TOLERANCES U.N.O. ON THE DRAWINGS: • DEVIATION FROM HORIZONTAL AND VERTICAL LINES 3/8" (15mm) IN 66'-0" (20m).
- DEVIATION OF BUILDING DIMENSIONS NOT MORE THAN 3/16" (5mm). • DEVIATION OF CROSS SECTIONAL DIMENSIONS OF COLUMNS OR BEAMS \pm 1/8" (\pm 3mm).
- 5. REFER TO ARCHITECTURAL DRAWINGS FOR CHAMFERS ON CORNERS OF COLUMNS, BEAMS AND WALLS. USE 7/8"x7/8" (20x20) FORMED CHAMFERS ON EXPOSED CORNERS UNLESS CHAMFERS OF OTHER SIZES ARE SHOWN ON DRAWINGS. REFER ALSO TO SPECIFICATION SECTION 031100.

REINFORCED CONCRETE WORK

- 1. SUBMIT SHOP DRAWINGS FOR ALL REINFORCING STEEL.
- 2. REINFORCING STEEL TO BE BILLET STEEL CONFORMING TO CAN/CSA G30.18-M92, GRADE 400. USE 400W WHERE WELDING IS NOTED.
- 3. BENDING, CUTTING AND PLACING OF REINFORCING STEEL SHALL CONFORM TO CAN/CSA-A23.4 AND CAN/CSA-A23.3.
- 4. WELDING SHALL CONFORM TO CSA-W186-M1990 (R2002).
- 5. REINFORCE SLABS ON GRADE WITH WWF 6"X6"W2.9/2.9 (152x152MW18.7/18.7) UNLESS OTHER REINFORCING IS SHOWN.
- WIRE MESH TO CONFORM TO CSA-G30.5-1983 (R1991).

STANDARD TIES AND CHAIRS.

- 7. ALL WELDED WIRE MESH SHALL BE SUPPLIED IN FLAT SHEETS AND CHAIRED IN PLACE TO THE REQUIRED COVER AS SPECIFIED.
- 8. REINFORCED CONCRETE WORK SHALL CONFORM TO THE REQUIREMENTS OF CAN/CSA-A23.1. CLEAN REINFORCING TO CAN/CSA-A23.1-94.
- 10. ALL REINFORCING STEEL SHALL BE CHAIRED AND SECURELY TIED IN PLACE USING

9. PROVIDE MATCHING CORNER BARS FOR ALL HORIZONTAL BARS AT ALL CORNERS AND

- 11. EPOXY COATED REINFORCING SHALL BE MANUFACTURED. FABRICATED. STORED. HANDLED AND INSTALLED IN STRICT ACCORDANCE WITH THE CSA STANDARDS AND INDUSTRY
- 12. MINIMUM REINFORCING BAR EMBEDMENT AND LAP SPLICE LENGTH TO CONFORM TO THE APPLICABLE REQUIREMENT LISTED BELOW (UNLESS OTHERWISE NOTED ON DRAWINGS):

		BAR EMBEDMENT AND LAP SPLICE TABLE						
_		TEN	SION	COMPRESSION				
	BAR SIZE	EMBEDMENT LENGTH	LAP SPLICE LENGTH	EMBEDMENT LENGTH	LAP SPLICE LENGTH			
	10M	16" (400mm)	20" (500mm)	8" (200mm)	12" (300mm)			
	15M	24" (600mm)	30" (750mm)	12" (300mm)	18" (450mm)			
	20M	30" (750mm)	40" (1000mm)	16" (400mm)	24" (600mm)			
	25M	48" (1200mm)	62" (1550mm)	20" (500mm)	30" (750mm)			
	30M	58" (1450mm)	74" (1850mm)	24" (600mm)	38" (900mm)			
	35M	66" (1650mm)	86" (2150mm)	28" (700mm)	42" (1050mm)			
	TABLE NOTES:			•				

- BASED ON CSA-A23.3-94
- THIS SCHEDULE IS FOR CLASS 'B' SPLICE U.N.O.
- APPLIES TO REINFORCING SPLICES NOT OTHERWISE DETAILED NORMAL DENSITY CONCRETE OF STRENGTH AT LEAST 25 MPa ENCLOSED BY MINIMUM STIRRUPS OR TIES
- CLEAR COVER AT LEAST 1.0 x BAR DIAMETER
- CLEAR SPACING AT LEAST 1.4 x BAR DIAMETER INCREASE LENGTHS TO 1.31 x LIST LENGTH FOR COATED REINFORCING
- . MINIMUM SLAB-ON-GRADE REINFORCEMENT TO CONFORM TO THE APPLICABLE REQUIREMENT LISTED BELOW (UNLESS OTHERWISE NOTED ON DRAWINGS):

MINIMUM SLAB REINFORCING TABLE				
SLAB THICKNESS	INTERIOR SLAB (As = 0.002xAg)	EXTERIOR SLAB (As = 0.0025xAg)		
MAX. 4" (100mm)	10M @ 18" (450mm)	10M @ 16" (400mm)		
4" - 5" (100mm - 125mm)	10M @ 16" (400mm)	10M @ 13" (325mm)		
5" - 6" (125mm - 150mm)	10M @ 13" (325mm)	10M @ 10 1/2" (265mm)		
6" - 7" (150mm - 175mm)	10M @ 11 1/4" (285mm)	10M @ 9" (225mm)		
7" - 8" (175mm - 200mm)	10M @ 10" (250mm)	10M @ 16" (400mm) TOP & BOTTOM		
" - 10" (200mm - 250mm)	10M @ 16" (400mm) TOP & BOTTOM	10M @ 13" (325mm) TOP & BOTTOM		

10" - 12" (250mm - 300mm)

- PROVIDE MINIMUM REINFORCING EACH WAY IN SLABS AND TOPPINGS WITHOUT
- SPECIFIED REINFORCING PROVIDE MINIMUM REINFORCING PERPENDICULAR TO PRINCIPAL REINFORCEMENT IN ONE-WAY SLABS. PLACE ALTERNATING TOP AND BOTTOM WHERE TOP REINFORCING IS SPECIFIED

10M @ 12" (325mm)

TOP & BOTTOM

10M @ 10 1/2" (265mm)

TOP & BOTTOM

14. MINIMUM END HOOKS FOR 400 GRADE REINFORCING TO CONFORM TO THE APPLICABLE

	STANDARD END HOOK	S TABLE
BAR SIZE	90° HOOK LENGTH	180° HOOK LENGTH
10M	7" (180mm)	5 1/2" (140mm)
15M	10" (260mm)	7" (180mm)
20M	12" (310mm)	8" (210mm)
25M	16" (400mm)	11" (280mm)
30M	20" (510mm)	15 1/2" (390mm)
35M	25 3/4" (640mm)	22" (550mm)

15. CONCRETE COVER TO REINFORCING STEEL SHALL CONFORM TO THE APPLICABLE

RE	EQUIREMENT LISTED BELOW THAT RESULTS IN THE GREAT AMOUNT OF	COVER:
•	CONCRETE CAST AGAINST EARTH CONCRETE CAST IN FORMS BUT EXPOSED TO EARTH OR WEATHER: • SLAB EXPOSED TO DEICING CHEMICALS	3" (75mm)
	TOP BARS BOTTOM BARS OTHER SLABS	2 3/8" (60mm) 1 1/2" (40mm)
	TOP BARS BOTTOM BARS	1 1/2" (40mm) 1 1/2" (40mm)
	BEAMS AND GIRDERS (TO STIRRUPS) GOLUMNIS AND BULL CARS (TO STIRRUPS)	1 1/2" (40mm)
	COLUMNS AND PILE CAPS (TO TIES) WALLS	1 1/2" (40mm) 1 1/2" (40mm)

•	CONCRETE NOT EXPOSED TO WEATHER OR NOT IN CONTACT WITH	EARTH:
	SLAB BOTTOM REINFORCING (2 HOUR OR LESS FIRE RATING)	1" (25mm)
	SLAB TOP REINFORCING	1" (25mm)
	BEAMS AND GIRDERS (TO STIRRUPS)	1 1/8" (30m
	COLUMNS AND PILE CAPS (TO TIES)	1 1/8" (30m
	WALLS (EXPOSED TO FIRE ON BOTH SIDES)	2" (50mm)

 OTHER WALLS 1" (25mm) 16. UNLESS NOTED OTHERWISE, PROVIDE DOWELS OF THE SAME SIZE, NUMBER AND SPACING WHERE REINFORCING IS SPLICED.

17. SUBMIT TO THE CONSULTANT FOR REVIEW THE LOCATION OF ALL CONSTRUCTION JOINTS NOT SHOWN ON THE DRAWINGS 18. HORIZONTAL CONSTRUCTION JOINTS SHALL NOT BE MADE IN BEAMS UNLESS SHOWN ON

19. SUBMIT TO THE CONSULTANT FOR REVIEW THE LOCATIONS OF ALL SLEEVES AND OPENINGS NOT SHOWN ON THE DRAWINGS. THE CONSULTANT WILL PROVIDE STRUCTURAL

DETAILS AS REQUIRED FOR SLEEVES AND OPENINGS.

20. SLEEVES SHALL NOT BE PLACED HORIZONTALLY ALONG OR VERTICALLY THROUGH BEAMS UNLESS AUTHORIZED BY THE CONSULTANT.

CAN/CSA-O141-91 (R1999), SOFTWOOD LUMBER

- PREFABRICATED WOOD TRUSSES
- 1. PREFABRICATED WOOD TRUSSES SHALL CONFORM WITH:
- CAN/CSA-O80 SERIES-97, WOOD PRESERVATION CAN/CSA-086.1-94, ENGINEERING DESIGN IN WOOD (LIMIT STATES DESIGN)
- CSA-S347-99, METHOD OF TEST FOR EVALUATION OF TRUSS PLATES USED IN LUMBER
- 2. ALL ROOF TRUSSES SHALL BE DESIGNED IN ACCORDANCE WITH CAN/ CSA-086.1 FOR THE LOADS APPLIED, INCLUDING DRIFT, ROOF FINISHES AND THE REQUIREMENTS OF THE
- LATEST PROVINCIAL BUILDING CODE, PART 4.
- 3. ROOF TRUSSES SHALL BE DESIGNED FOR A MAXIMUM LIVE LOAD DEFLECTION OF L/360. 4. WOOD TRUSS FABRICATOR SHALL SUBMIT TRUSS SHOP DRAWINGS
- ENGINEERED SEALED SHOP DRAWINGS INCLUDING THE LAYOUT, DESIGN CRITERIA, CONNECTIONS AND DETAILS SHALL BE SUBMITTED PRIOR TO FABRICATION FOR REVIEW BY OWNERS REPRESENTATIVE
 - INDICATE SPECIES, SIZES AND STRESS GRADES OF LUMBER USED AS TRUSS MEMBERS. SHOW PITCH, SPAN, CAMBER, CONFIGURATION AND SPACING OF TRUSSES.
- SHOW BEARING DETAILS AND INDICATE THE DESIGN LOAD FOR MEMBERS. INDICATE ARRANGEMENT OF WEBS OR OTHER MEMBERS TO ACCOMMODATE DUCTS
- AND OTHER SPECIALTIES. SHOW LIFTING POINTS FOR STORAGE, HANDLING, AND ERECTION SHOW LOCATION OF LATERAL BRACING FOR COMPRESSION MEMBERS

VERIFY ALL DIMENSIONS WITH THE CONTRACTOR PRIOR TO FABRICATION. OBTAIN ALL

MANUFACTURED IN ACCORDANCE WITH THE STRUCTURE IN PLACE. 5. GIRDER TRUSS LOCATIONS THAT ARE SHOWN ON THE BUILDING STRUCTURAL DRAWINGS

REQUIRED FIELD MEASUREMENTS WHERE POSSIBLE SO THAT TRUSSES ARE

- SHALL NOT BE RELOCATED WITHOUT THE APPROVAL OF THE STRUCTURAL ENGINEER OF
- DIMENSIONS ARE SHOWN ON THE BUILDING STRUCTURAL DRAWINGS. 7. STORE TRUSSES ON JOB SITE IN ACCORDANCE WITH MANUFACTURERS INSTRUCTIONS. PROVIDE BEARING SUPPORTS AND BRACING. PREVENT BENDING WARPING AND

6. DESIGN WOOD TRUSSES TO ACCOMMODATE MECHANICAL DUCTING WHEN CAVITY

- OVERTURNING OF TRUSSES. 8. THE ERECTION CONTRACTOR SHALL BE SUPPLIED WITH DETAILED INSTRUCTIONS FOR THE CARE, STORAGE, HANDLING, AND ERECTION OF THE TRUSSES INCLUDING A LAYOUT PLAN
- 9. INSTALL ALL TEMPORARY BRACING TO HOLD TRUSSES PLUMB AND IN A SAFE CONDITION
- UNTIL PERMANENT BRACING AND DECKING ARE INSTALLED. ALL TEMPORARY BRACING AND GUARDS SHALL BE THE RESPONSIBILITY OF THE CONTRACTOR. 10. INSTALL ALL PERMANENT BRACING AND BRIDGING INDICATED ON THE SHOP DRAWINGS
- PRIOR TO APPLICATION OF SIGNIFICANT FLOOR/ROOF LOADS. 11. CONTRACTOR SHALL NOT CUT, DRILL, NOTCH, OR MODIFY THE TRUSSES IN ANY WAY EXCEPT IN STRICT ACCORDANCE WITH THE MANUFACTURERS INSTRUCTIONS AND THE APPROVAL OF THE OWNERS REPRESENTATIVE.

1. ALL LUMBER, SHEATHING AND MANUFACTURED WOOD PRODUCTS SHALL MEET OR EXCEED

- THE APPLICABLE CSA STANDARD FOR THAT PRODUCT. USE ONLY PRODUCTS SUITABLE FOR THE INTENDED FINAL USE AND CONDITIONS PREVALENT DURING CONSTRUCTION. PROTECT ALL MATERIALS FROM THE WEATHER DURING STORAGE AND INSTALLATION
- 2. ALL WOOD STUDS, LINTELS, JOISTS, POSTS, AND BEAMS TO BE S.P.F. #2 OR BETTER.
- 3. ALL FRAMING LUMBER SHALL BE KILN DRIED TO A MOISTURE CONTENT OF LESS THAN 19% AT THE TIME OF MANUFACTURING.

4. ALL WOOD FRAMING TO CONFORM TO PART 9 OF THE PROVINCIAL BUILDING CODE UNLESS

OTHERWISE SHOWN ON THE DRAWINGS. 5. ALL BUILT UP WOOD BEAMS SHALL BE SUPPORTED BY A POST CONSISTING OF A MINIMUM OF 1 (ONE) STUD FOR EACH PLY OF BEAM WHEN INCORPORATED IN A WALL. ALL FREE

STANDING BUILT UP POSTS SHALL BE A MINIMUM OF 3 (THREE) LAMINATIONS. SEE

- DRAWINGS FOR EXCEPTIONS TO THIS REQUIREMENT. 6. ALL BUILT UP LAMINATED VENEER TYPE BEAMS SHALL BE SUPPORTED BY A POST CONSISTING OF A MINIMUM OF 1 (ONE) MORE STUD THAN THE NUMBER OF PLYS OF BEAM WHEN INCORPORATED IN A WALL (EG. 3 STUDS FOR A 2 PLY BEAM). ALL FREE STANDING BUILT UP POSTS SHALL BE A MINIMUM OF 3 (THREE) LAMINATIONS. SEE DRAWINGS FOR
- MINIMUM OF 1 (ONE) STUD PLUS 2 (TWO) CRIPPLES (JACKS) ON EACH END, SECURELY TIED INTO THE WALL. INTERMEDIATE POSTS FOR CONTINUOUS LINTELS SHALL MEET THE BEAM REQUIREMENTS ABOVE. SEE DRAWINGS FOR EXCEPTIONS TO THIS REQUIREMENT.

7. ALL BUILT UP WOOD LINTELS FOR WINDOWS AND DOORS SHALL BE SUPPORTED BY A


- 8. ALL TWO STOREY WALLS AND SPLIT LEVEL WALLS WITHOUT INTERMEDIATE FLOORS SHALL BE BALLOON FRAMED TO PREVENT HINGING. NO SPLICES UNLESS DETAILED OTHERWISE.
- 9. ALL SUB FLOOR SHEATHING SHALL BE SCREWED AND GLUED TO THE JOISTS WITH A SUITABLE PRODUCT FOR CONSTRUCTION AND THE PREVALENT WEATHER CONDITIONS. 10. THE CONTRACTOR SHALL BRING ANY DISCREPANCIES IN DIMENSIONS ETC. TO THE
- ATTENTION OF THE OWNERS REPRESENTATIVE PRIOR TO COMMENCING WORK 11. ALL TEMPORARY BRACING AND GUARDS SHALL BE THE CONTRACTORS RESPONSIBILITY.
- 12. PROVIDE WOOD BLOCKING ALONG SHEATHING JOINTS (TYPICAL).

100MMØ PIPE OR SMALLER

125MMØ PIPE

EXCEPTIONS TO THIS REQUIREMENT.

- TYPICAL MECHANICAL WATER LINE LOADINGS
- 1. REFER TO MECHANICAL DWGS. FOR SPRINKLER LINE LOCATIONS. 2. ALL JOISTS SUPPORTING MECHANICAL WATER LINES SHALL BE DESIGNED TO WITHSTAND WATER FILLED PIPE LOADS 'W' AS SHOWN BELOW IN ADDITION TO THE SPECIFIED DESIGN

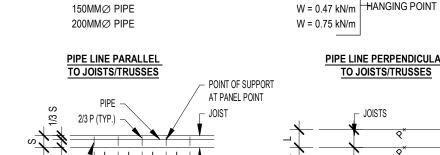

P = wL = 100 LBS.

w = SEE ABOVE (DIAM. OF PIPE).... P.L.F

L = SPACING OF PIPE SUPPORTS...MM.

IGNORE ____

W = 0.35 kN/m | PLUS 0.45 kN AT

STEEL SCREW PILES - HELICAL

1. REFERENCE STANDARDS:

- AMERICAN SOCIETY FOR TESTING MATERIALS (ASTM)
- ASTM A153/A153M-05 STANDARD SPECIFICATION FOR ZINC COATING (HOT-DIP) ON IRON AND STEEL HARDWARE.
- ASTM A36/A36M-05 STANDARD SPECIFICATION FOR CARBON STRUCTURAL STEEL. ASTM A252-98(2007) STANDARD SPECIFICATION FOR WELDED AND SEAMLESS STEEL
- CANADIAN STANDARDS ASSOCIATION (CSA) GDFCAN/CSA-G40.21, STRUCTURAL QUALITY STEELS CAN/CSA-G164-M92, HOT DIP GALVANIZING OF IRREGULARLY SHAPED ARTICLES.
- · CSA W47.1-92, CERTIFICATION OF COMPANIES FOR FUSION WELDING OF STEEL STRUCTURES CSA W48 SERIES, ELECTRODES

CAN/CSA-S16.1-06, LIMIT STATES DESIGN OF STEEL STRUCTURES.

CSA W55.3, RESISTANCE WELDING QUALIFICATION CODE FOR FABRICATORS OF STRUCTURAL MEMBERS USED IN BUILDINGS. CSA W59, WELDED STEEL CONSTRUCTION (METAL ARC WELDING).

DESIGN CRITERIA:

- DESIGN CONNECTIONS AND OTHER WORK NOT DETAILED ON DRAWINGS, BUT NECESSARY FOR COMPLETION OF THE WORK. IN ACCORDANCE WITH REQUIREMENTS OF ALBERTA BUILDING CODE, CAN/CSA_S16.1 AND CSA S136.
- COMPLY WITH REQUIREMENTS OF DIVISION 1. UPON RECEIPT OF SUBMITTALS, THE CONSULTANT SHALL HAVE 14 DAYS FOR SHOP DRAWINGS AND 72 HOURS FOR REQUESTS FOR INFORMATION, EXCLUDING WEEKENDS
- AND STATUTORY HOLIDAYS. FOR PROCESSING. COORDINATING AND PROVIDING SUCH INFORMATION. THE CONSULTANT WILL NOT BE HELD LIABLE FOR DELAYS WITHIN THIS SUBMIT SHOP DRAWINGS AND PRODUCT DATA PRIOR TO COMMENCEMENT OF
- FABRICATION SHOP DRAWINGS SHALL INCLUDE SHOP DETAILS AND ERECTION DIAGRAMS AND SHALL | EQ SP INDICATE METHOD OF TORQUING AND WELDS USING AMERICAN WELDING SOCIETY BASIC WELD SYMBOLS SHOP DRAWINGS FOR WORK DESIGNED BY FABRICATORS SHALL BEAR THE SEAL AND
- SUBMIT SHOP PAINT PRIMER MANUFACTURER'S PRODUCT DATA. • SUBMIT THREE COPIES OF CERTIFIED MILL TEST REPORTS FOR THE MATERIALS USED.

SIGNATURE OF A PROFESSIONAL ENGINEER REGISTERED IN THE PROVINCE OF

 USE EQUIPMENT TO MINIMIZE ENVIRONMENTAL IMPACT ON SITE. IDENTIFY ALL UNDERGROUND SERVICES PRIOR TO INSTALLATION. ENSURE ALL SERVICES ARE PROPERLY MARKED AND IDENTIFIED BY THE PROPER AUTHORITIES.

- INSTALLATION TO BE PERFORMED BY AN EXPERIENCED CERTIFIED CONTRACTOR. INSTALL HELICAL SCREW-IN PILES TO DEPTHS, TORQUES AND POSITIONS AS INDICATED H2E
- BY CONSULTAN INSTALL SCREW-IN PILES IN A SMOOTH AND CONTINUOUS MANNER, RATE OF ADVANCE 5 TO 20 RPM. THE RATE OF ADVANCE SHOULD MATCH THE PITCH ON THE PILE. APPLY SUFFICIENT DOWNWARD PRESSURE TO AID IN THE ADVANCEMENT OF THE PILE INTO PILE INSTALLATION CERTIFICATE AND/OR LETTER OF ASSURANCE BEARING THE SEAL

OF A REGISTERD PROFESSIONAL ENGINEER TO BE PROVIDED TO THE CONSULTANT AS

FABRICATION:

- SHOP FABRICATE COMPONENTS WHERE POSSIBLE. FABRICATE COMPONENTS SQUARE, STRAIGHT, TRUE, FREE FROM WARPAGE AND
- OTHER DEFECTS. ACCURATELY CUT, MACHINE, FILE AND FIT JOINTS, CORNERS, COPES EXPOSED JOINTS AND CONNECTIONS TO BE TIGHT, FLUSH AND SMOOTH UNLESS OTHERWISE INDICATED

WHERE WORK OF OTHER SECTIONS IS TO BE ATTACHED TO WORK OF THIS SECTION, PREPARE WORK BY DRILLING AND TAPPING HOLES AS REQUIRED TO FACILITATE

INSTALLATION OF SUCH WORK.

- SURFACE PREPARATION: THOROUGHLY CLEAN AND SUITABLY PRETREAT STEEL PRIOR TO FINISHING REMOVE LOOSE MILL SCALE, RUST, OIL, GREASE, DIRT AND OTHER FOREIGN MATTER.
- WIRE BRUSHING POWER WIRE BRUSHING

USING ONE OR MORE OF THE FOLLOWING METHODS:

CONSULTANT.

- 8. EQUIPMENT: USE HYDRAULIC DRILL HEAD. PROVIDE TORQUE MONITORING DEVICE AS PART OF THE INSTALLATION UNIT OR AS A
- SEPARATE IN-LINE DEVICE CAPABLE OF RECORDING TORQUE OR PRESSURE. TORQUE SHOULD BE MONITORED DURING THE ENTIRE INSTALLATION. CALIBRATED TORQUE MONITORING DATA TO BE MADE AVAILABLE TO THE CONSULTANT UPON REQUEST

POSITION SCREW-IN PILE AS INDICATED ON DRAWINGS. PLACE ANCHOR TIP ON PINNED LOCATION. ESTABLISH THE PROPER ANGULAR ALIGNMENT AT START OF INSTALLATION.

- INSTALLATION RECORDS TO BE MAINTAINED FOR ALL SCREW-IN PILES. CONTRACTOR TO RECORD PILE SIZE AND LOCATION, INSTALLED TORQUE, FINISH DEPTH AND PILE DESCRIPTION. PROVIDE APPROVED ADAPTERS TO THE INSTALLATION UNIT. PIN PIERS AND EXTENSIONS TO THE ADAPTER IN A SAFE AND CONTROLLED MANNER, USING TWO PINS.
- IF SOIL CONDITIONS APPEAR DIFFICULT (GRAVELLY, ROCKY, COBBLED OR VERY HARD), PROVIDE OFFSET MARKS FOR PILE POSITION REFERENCES AS REQUESTED BY CONSULTANT.

USE TWO HIGH STRENGTH BOLTS WITH NUTS PER COUPLER CONNECTION.

PILES, SHOULD BE REVIEWED BY CONSULTANT. MINIMUM EMBEDMENT DEPTH IS 5 TIMES THE DIAMETER OF THE UPPERMOST HELIX OR AS SPECIFIED ON THE CONSTRUCTION DOCUMENTS. DEPTH AND TORQUE TOLERANCES: SCREW-IN PILES THAT REACH MAXIMUM TORQUE

RATING BEFORE REACHING MINIMUM INDICATED DEPTH SHALL REVIEWED BY THE

IF OBSTRUCTIONS PRESENT A PROBLEM. THE OBSTRUCTION MUST BE REMOVED OR

THE PILE RELOCATED. THIS RELOCATION MAY AFFECT THE RELOCATION OF OTHER

STANDARD STRUCTURAL DRAWING ABBREVIATIONS PERIMETER ALTERNATE APPROX OR ± APPROXIMATELY PFRP PERPENDICULAR ARCHITECT PROJECT POST TENSIONED BOTTOM LOWER LAYER R OR RAD BOTTOM UPPER LAYER **ROOF DRAIN** REINFORCE WITH REINFORCING CATCH BASIN REMAINDER CAST IN PLACE REQUIRED CONSTRUCTION JOINT STEP DOWN FOOTING CENTRE LINE CENTRE TO CENTRE COMPLETE WITH SAWCUT JOINT SLAB ON GRADE CONCRETE STANDARD PROCTOR MAXIMUM DRY DENSITY CONTINUOUS STAINLESS STEEL DEEP OR DEPTH SIMPSON STRONG-TIE DIA OR Ø DIAMETER STANDARD STIFFENER DIAGONAL DO OR Do SYMMETRICAL DOWEL TOP & BOTTOM EACH END TOP OF FOOTING ELEVATION T/F EL EACH FACE **EXPANSION JOIN** THICK EACH SIDE TOP LOWER LAYER EACH WAY TOP UPPER LAYER EL OR ELEV ELEVATION ELECTRICAL **TYPICAL EQUAL SPACES** UNDERSIDE OF UNIFORMLY DISTRIBUTED LOAD EXIST, EXT'G OR EX. EXISTING U.N.O UNLESS NOTED OTHERWISE VERTICAL FAR SIDE FOUNDATION FLAT PLATE WIDE OR WIDTH WORKING POINT FULL MOMENT CONNECTION WELDED WIRE MESH FULL TENSION SPLICE GALVANIZED **FORCES** GR BM GRADE BEAM FACTORED COMPRESSIVE FORCE kN HIGH OR HEIGHT HOOKED EACH END HOOK ONE END FACTORED BENDING MOMENT ABOUT X-X AXIS, kN-m HOOK TWO ENDS FACTORED BENDING MOMENT ABOUT Y-Y AXIS, kN-m HOT DIPPED GALVANIZED FACTORED PASS THROUGH FORCE HORIZONTAL FACTORED TORSIONAL MOMENT, kN-M FACTORED TENSION FORCE, kN FACTORED VERTICAL (ABOUT Y-Y AXIS) END SHEAR INSIDE DIAMETER FORCE (REACTION), kN INSIDE FACE FACTORED VERTICAL (ABOUT X-X AXIS) END SHEAR INCLUDING FORCE (REACTION), kN INSULATION UNFACTORED LIVE LOAD ON STEEL DECK, PRECAST INTERIOR UNFACTORED DEAD LOAD ON STEEL DECK, PRECAST OR OWSJ'S LOCATION LONGITUDINAL LONG LEG VERTICAL LONG LEG HORIZONTAI LONG SIDE VERTICAL LONG SIDE HORIZONTAL SQUARE FOOT MILD STEEL KII OGRAM KILONEWTON MECHANICAL KIP(S) PER FOOT MEZZANINE MINIMUM KILONEWTON METRE KIP(S) PER SQUARE FOOT MISCELLANEOUS KILONEWTON PER METRE NELSON DEFORMED BARS KILONEWTON PER SQUARE METRE NOT IN CONTRACT KIP(S) PER SQUARE INCH NEAR SIDE KILOPASCAL POUND(S) NELSON STUD N.T.S NOT TO SCALE METRE SQUARE METRE No. OR # NUMBER NEWTON **OUTSIDE DIAMETER** POUNDS PER FOOT OUTSIDE FACE POUNDS PER SQUARE FOOT POUNDS PER SQUARE INCH OPPOSITE OPENING PASCAL OPEN WEB STEEL JOIST MEGAPASCAL

Z

REPORT ANY DISCREPANCIES OR OMISSIONS TO THE CONSULTANT IMMEDIATELY. FAILURE TO DO SO SHALL NOT BE GROUNDS FOR

IN THE CASE OF A DISCREPANCY BETWEEN THE CONTRACT

DOCUMENTS, DRAWINGS OF LARGER SCALE SHALL GOVERN OVER

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PROF. SEAL:

REVISION SCHEDULE

REVISION

2020.05.20

2020.06.02

CLEARHILLS COUNTY

ISSUED FOR:

90% CLIENT REVIEW

TENDER


CLEARHILLS FIREHALL

SITE DESCRIPTION: LOT 84 & 85, BLOCK 1, PLAN 07262595,

CLEARDALE, CLEARHILLS COUNTY, AB

DRAWN BY: GB PROF. REVIEW: TECH. REVIEW: JW FINAL REVIEW: SPA PROJECT NUMBER:

DRAWING NUMBER

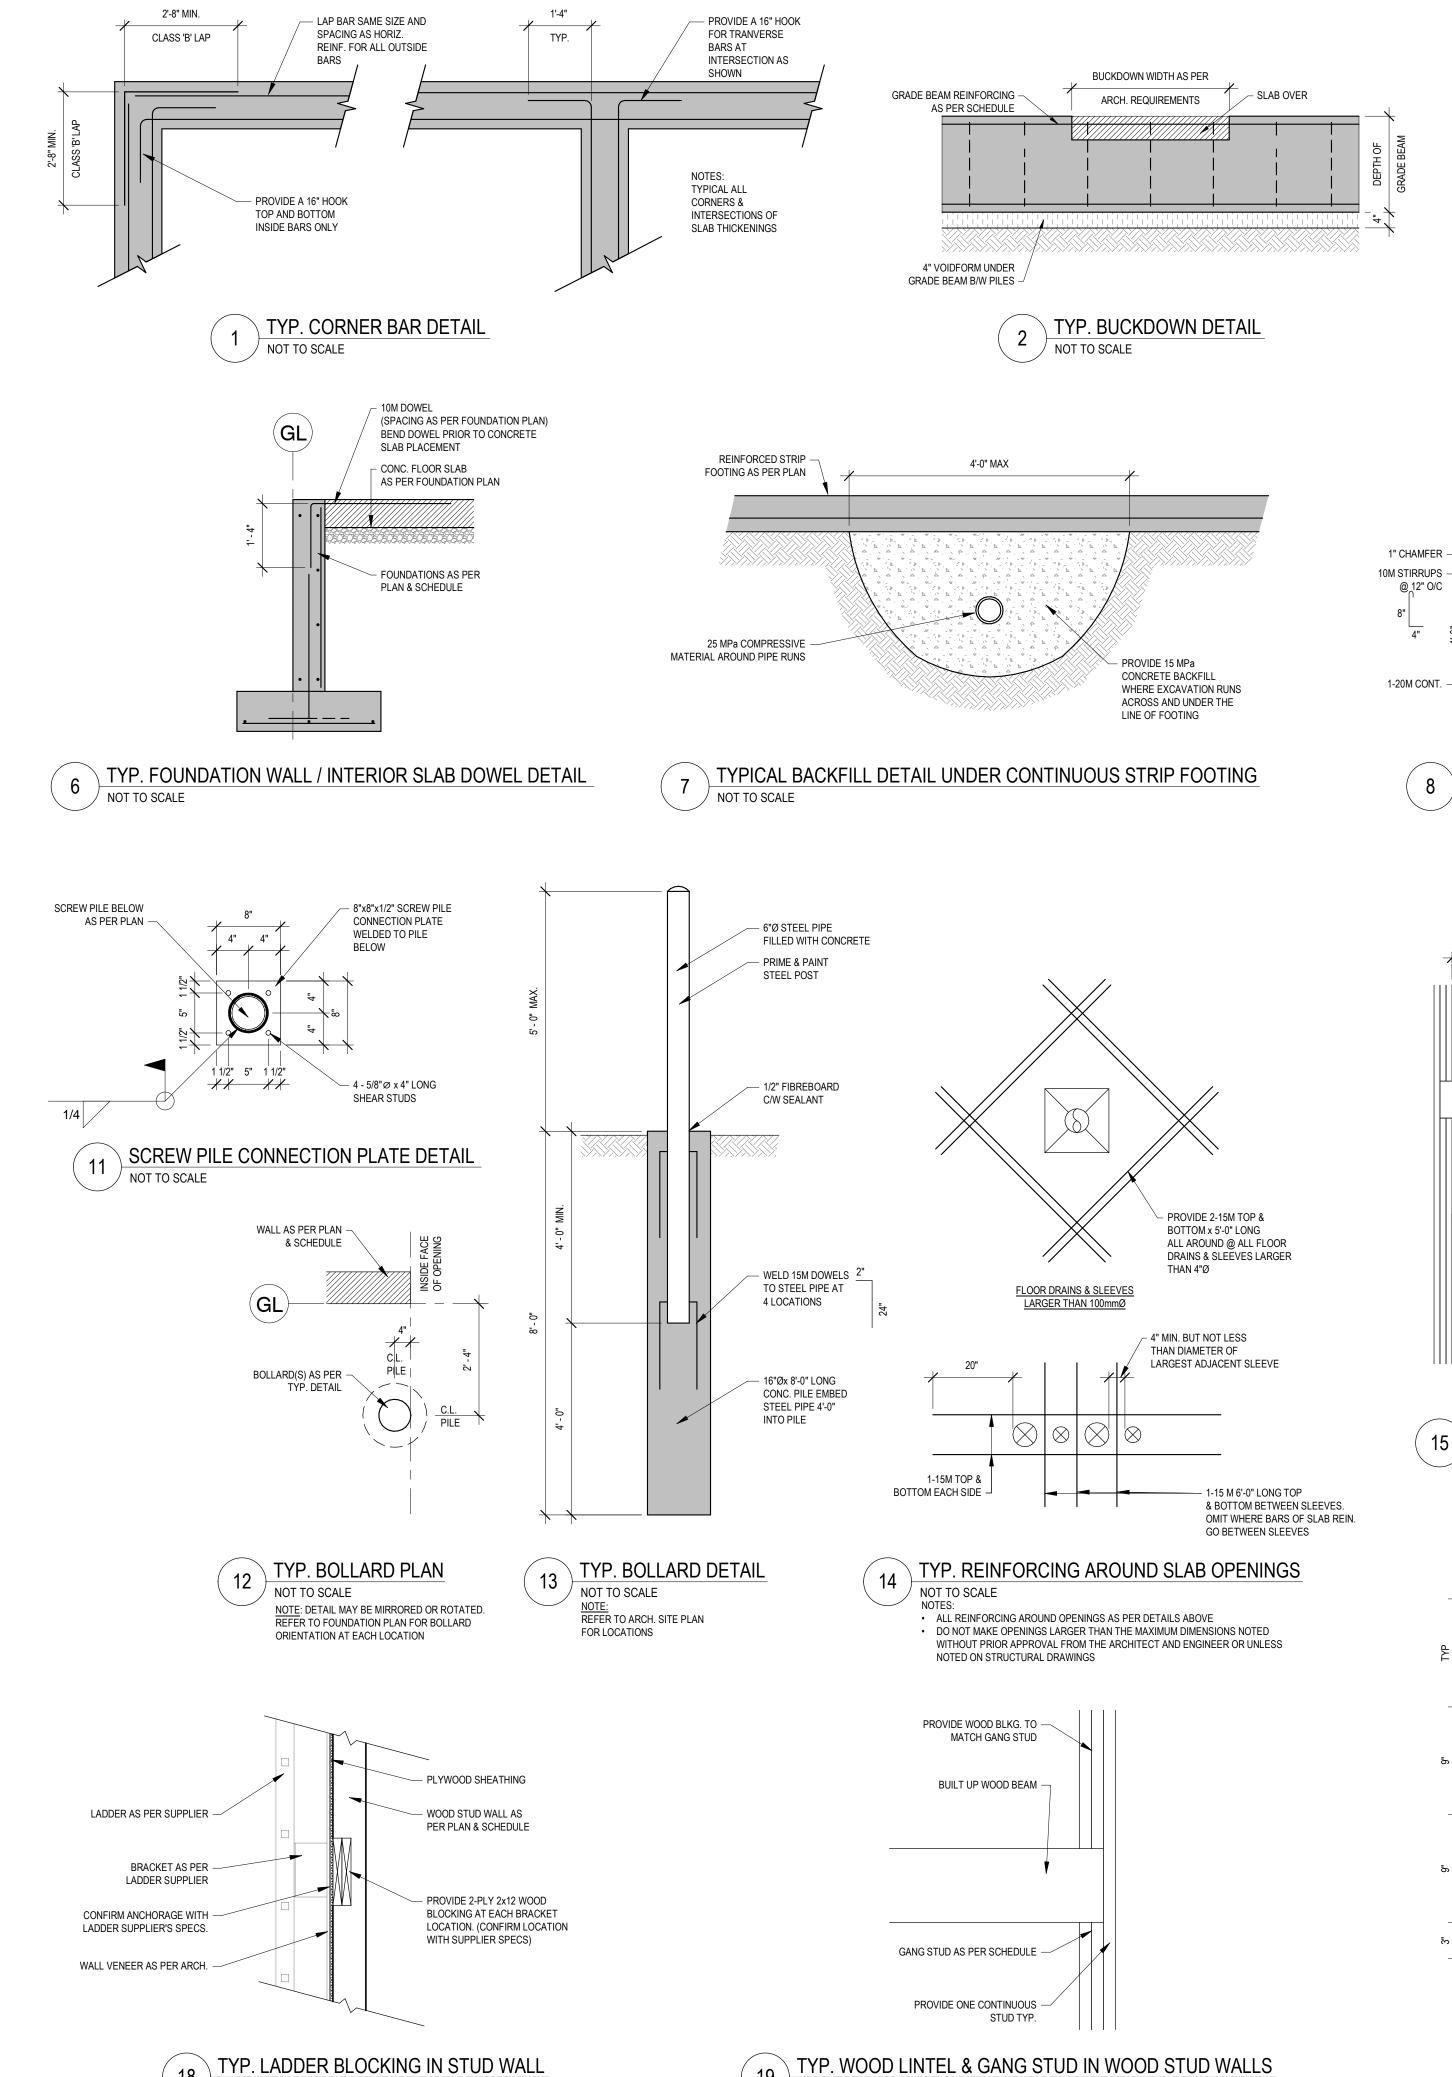


NOT TO SCALE

NOT TO SCALE

REFER TO ARCH FOR LOCATION OF LADDER

 CONFIRM WITH LADDER SPECIFICATIONS FOR NUMBER OF BRACKET LOCATIONS

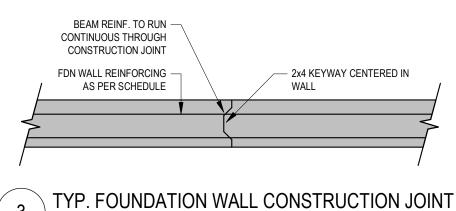

- SLAB DOWELS

- CONC. SLAB AS

- FOUNDATION AS

PER PLAN

PER PLAN

AS PER PLAN

AS PER PLAN

5" CONC. SLAB ON GRADE -

R/W 15M @ 12" O/C E/W

6" COMPACTED CRUSH

2" RIGID INSULATION

UNDISTURBED SOIL

15M DOWELS @ 12" O/C —

CONNECTION AS PER

SCREW PILES AS PER PLAN

TYP. MECH OPENING FRAMING IN STUD WALLS

REFER TO MECH. FOR SIZE & LOCATION OF OPENINGS.

SCREW PILE

TYP. DETAIL

TYP. CONCRETE APRON @ PILE

EXTERIOR FLATWORK WITH ARCHITECTURAL SITE PLAN

NOTE:
CONFIRM DIMENSIONS & LOCATIONS OF ALL

NOT TO SCALE





1" CHAMFER -

10M STIRRUPS -

1-20M CONT.

@_12" O/C

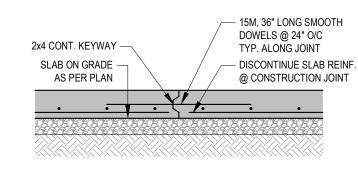

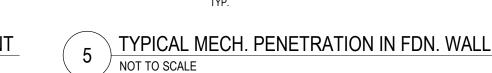


- FOUNDATION WALL AS

- REINFORCE OPENING W/

PLAN AND DETAIL

2-20M BARS

E/S OF OPENING

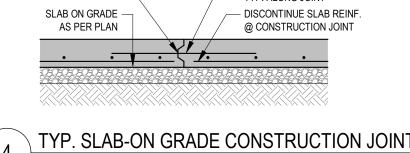

CAST SLAB OVER

- FOUNDATION AS

PER PLAN

DOOR BUCKDOWN

AS PER PLAN

6" CONC. SLAB ON GRADE -

R/W 15M @ 12" O/C E/W 2" RIGID INSULATION

6" COMPACTED CRUSH

UNDISTURBED SOIL

15M DOWELS -


@ 12" O/C

TYP. CONCRETE APRON @ OVERHEAD DOOR

NOTE: CONFIRM DIMENSIONS & LOCATIONS OF ALL


EXTERIOR FLATWORK WITH ARCHITECTURAL SITE PLAN


REFER TO MECH. FOR SIZE & LOCATION OF OPENINGS.

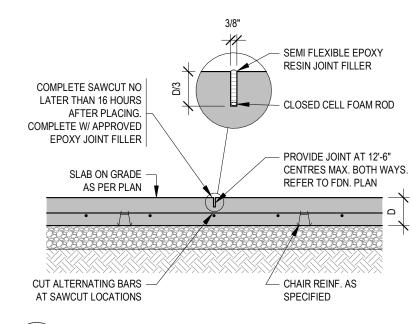



TYP. SLAB-ON GRADE CONTROL JOINT

POUR JOINT FILLER HIGHER THAN CONCRETE AND GRIND LEVEL AFTERWARDS. DO NOT RUN WHEELED EQUIPMENT OVER JOINT UNTIL FILLED. FILL JOINT AS LATE AS POSSIBLE AFTER PLACING CONCRETE TO ALLOW AS MUCH SHRINKAGE TO TAKE PLACE AS

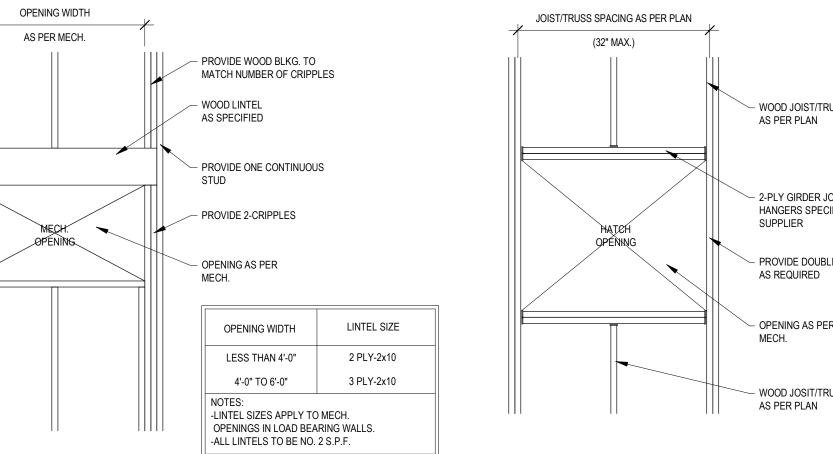

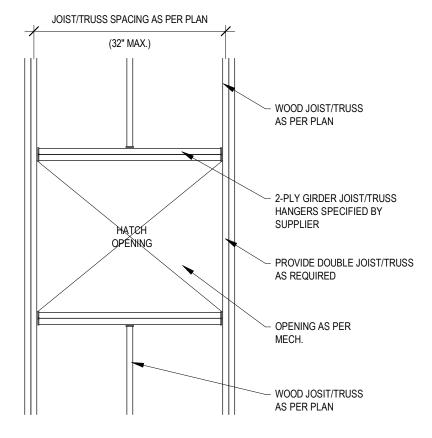

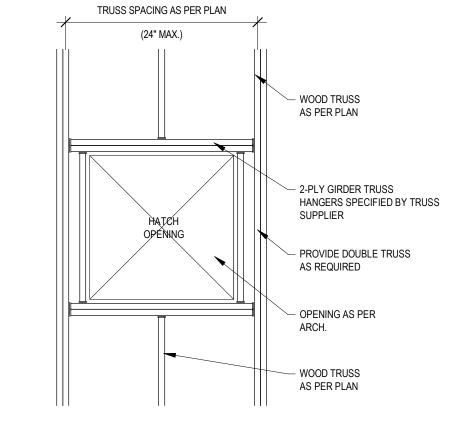

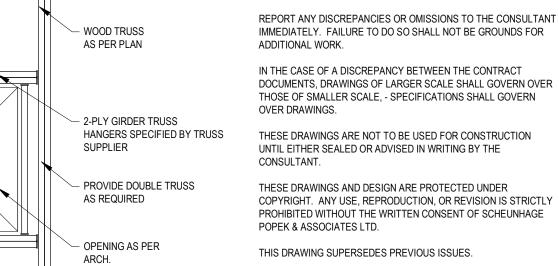


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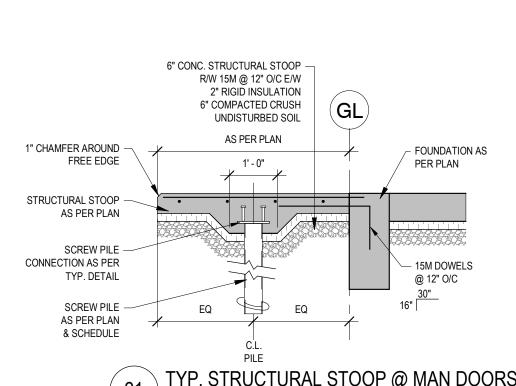
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PROF. SEAL:



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2 1/4" 2 3/4" 2 1/4"	En	2 1/4" 2 3/4" 2 1/4"	ēn En



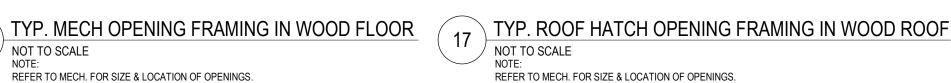

TYP. STRUCTURAL STOOP @ MAN DOORS NOT TO SCALE CONFIRM DIMENSIONS & LOCATIONS OF ALL

EXTERIOR FLATWORK WITH ARCHITECTURAL SITE PLAN

ISSUED FOR: REVISION 90% CLIENT REVIEW 2020.05.20 2020.06.02 TENDER

REVISION SCHEDULE

CLEARHILLS COUNTY


CLEARHILLS FIREHALL


SITE DESCRIPTION: LOT 84 & 85, BLOCK 1, PLAN 07262595,

CLEARDALE, CLEARHILLS COUNTY, AB

TYPICAL DETAILS

GB PROF. REVIEW: DRAWN BY: JW FINAL REVIEW: TECH. REVIEW: SPA PROJECT NUMBER: 20-048 DRAWING NUMBER: REVISION:

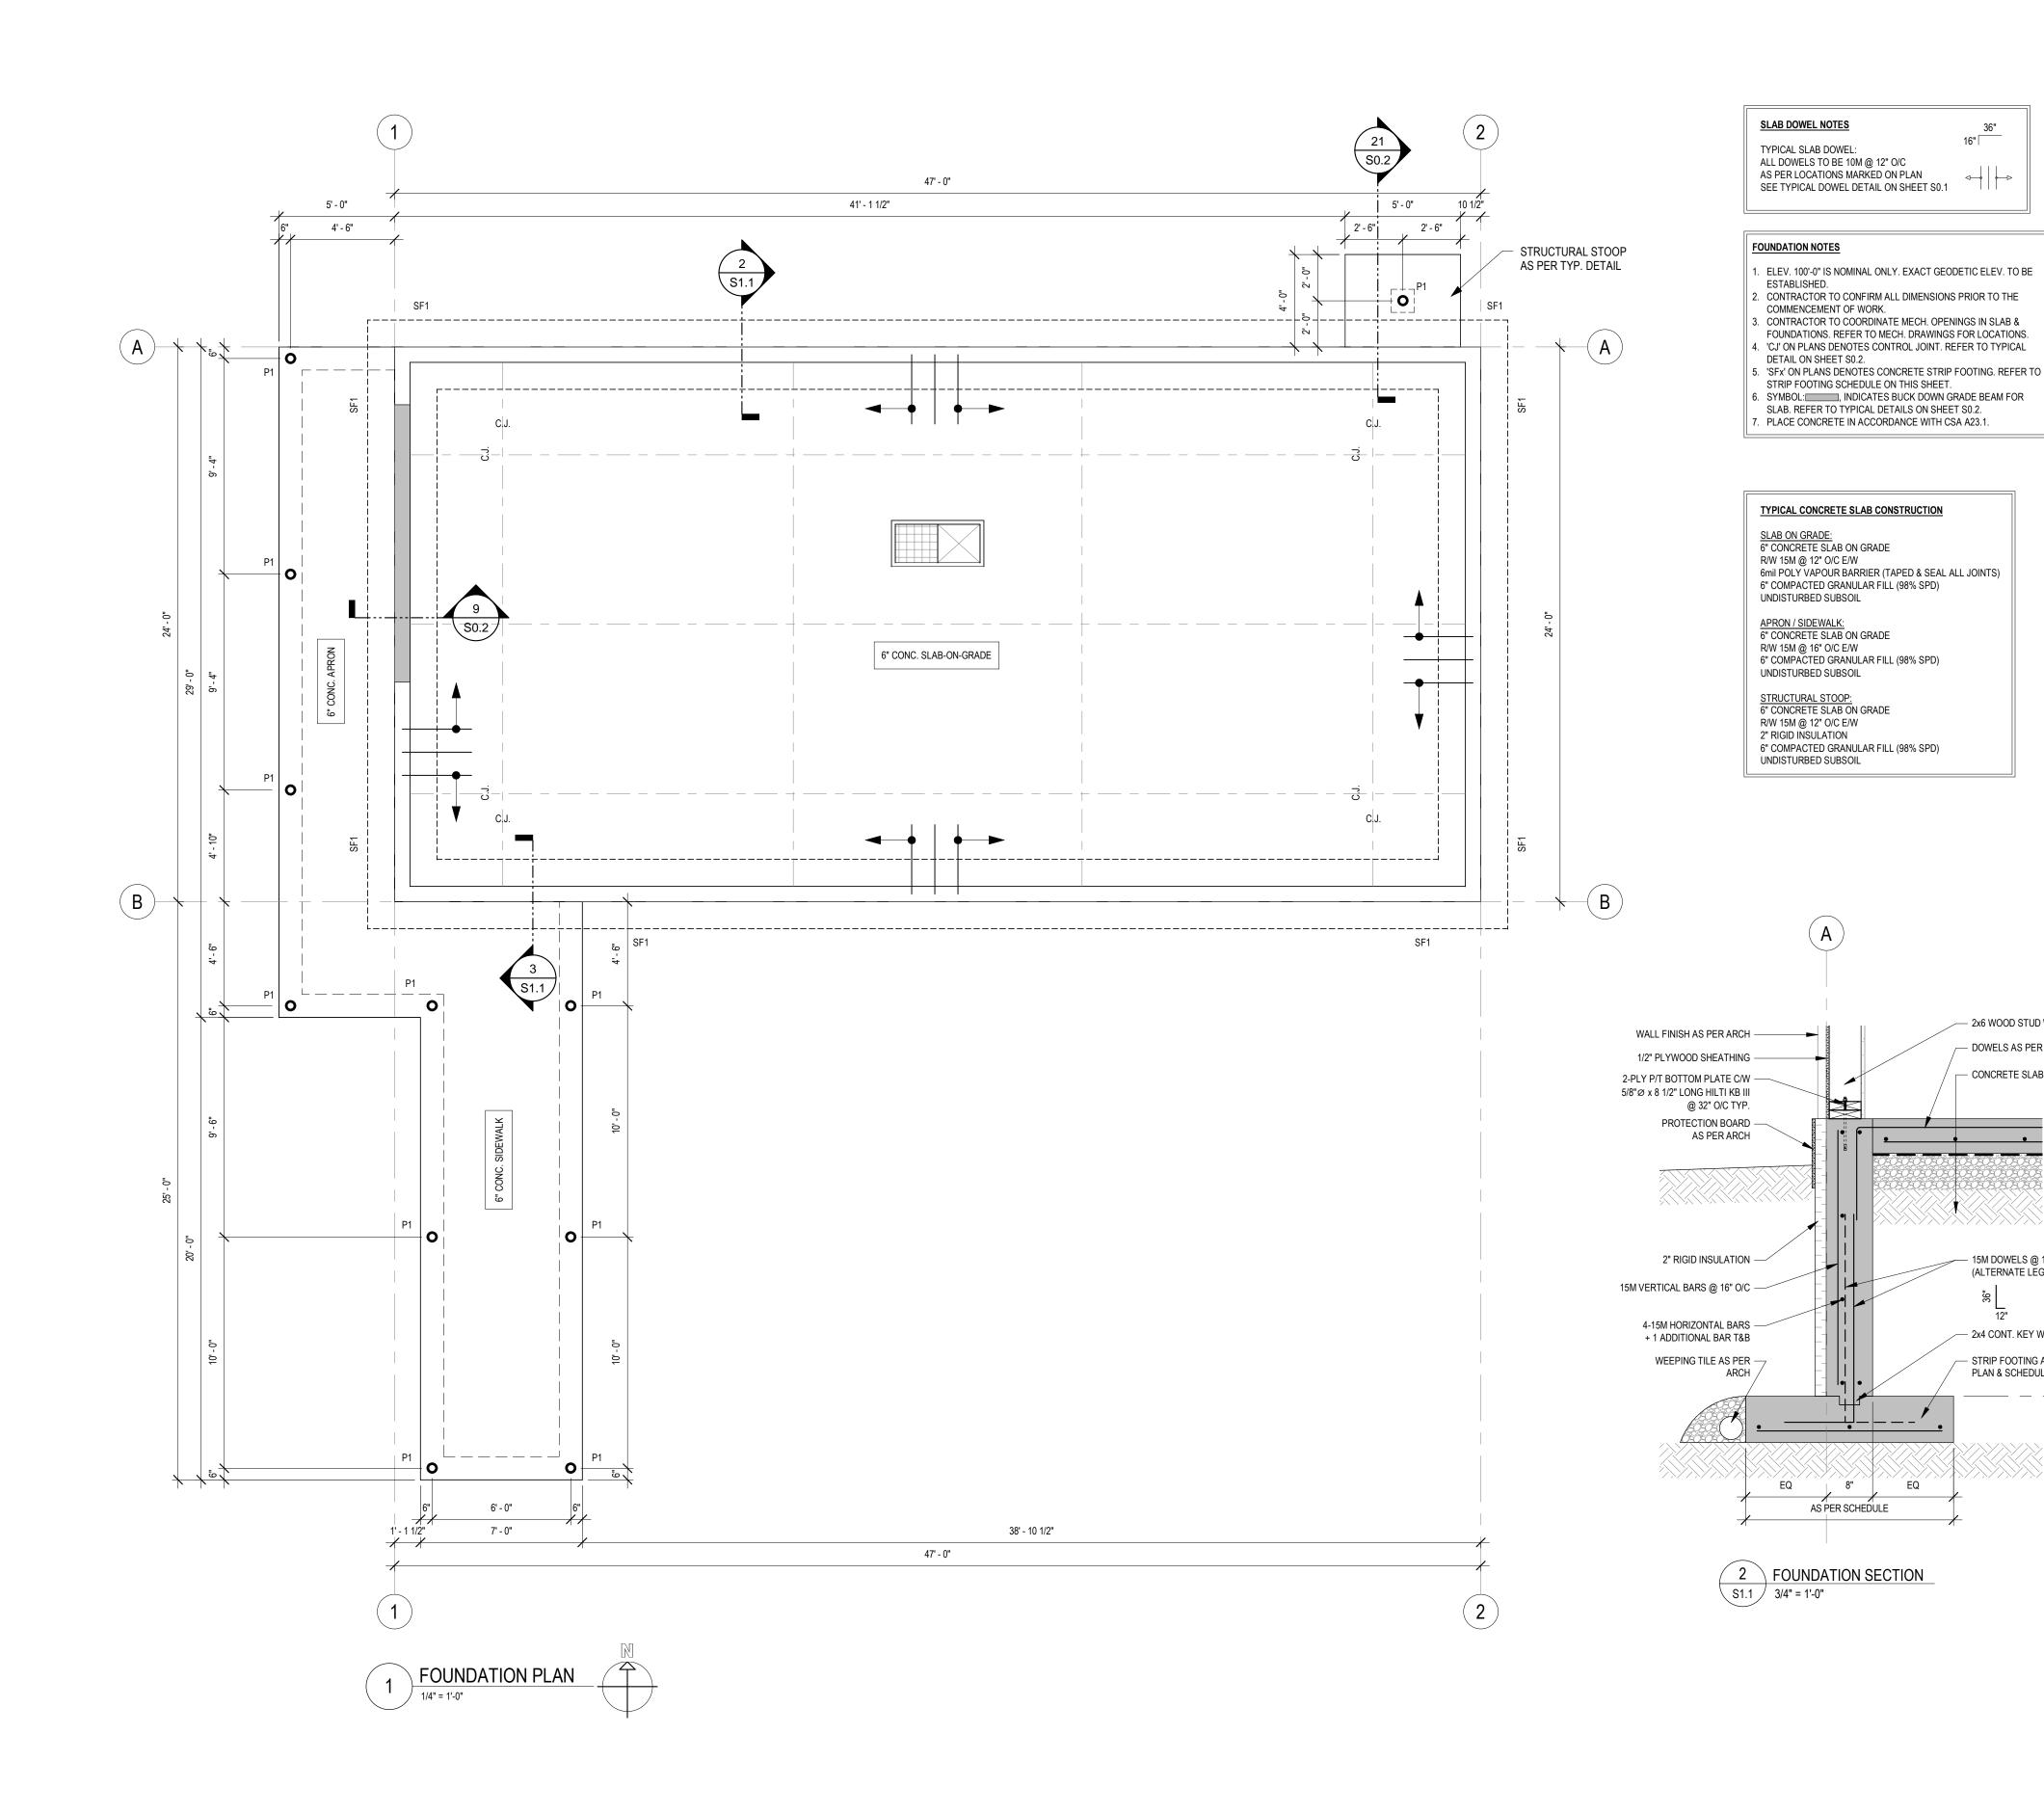

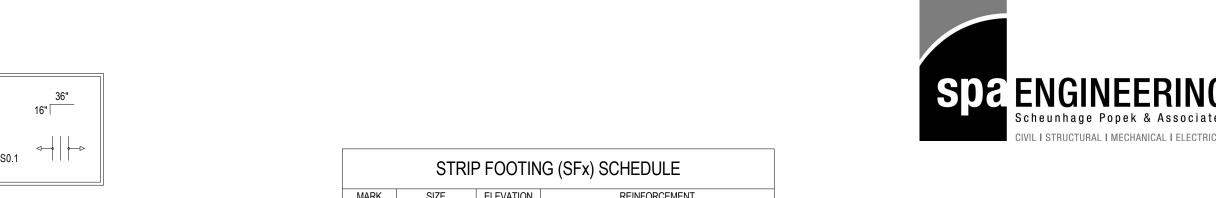

 SF1
 36" x 8" THICK
 96' - 0"
 3-15M LONGITUDINAL & 15M TRANSVERSE @ 16" O/C

SCREW PILE (SPx) SCHEDULE MARK SHAFT DIA. THICKNESS HELIX DIA. THICKNES DEPTH RESISTANCE (kN) REMARKS
P1 4 1/2" 1/4" 10" 3/4" 14' - 0" 43 SINGLE HELIX

SCREW PILE NOTES

- 2x6 WOOD STUD WALL AS PER PLAN & SCHEDULE

DOWELS AS PER PLAN

15M DOWELS @ 16" O/C

2x4 CONT. KEY WAY TYP.

- STRIP FOOTING AS PER

PLAN & SCHEDULE


ÉQ

(ALTERNATE LEG DIRECTION)

CONCRETE SLAB AS PER PLAN

1. 'SPx' ON PLANS DENOTES STEEL PILE. REFER TO PILE SCHEDULE ON THIS SHEET.

- 2. ALL STEEL BOLTS ANS STUDS TO CONFORM TO ASTM A325 3. ALL PIPE MATERIAL SHALL BE A252 GRADE 3 310MPa YIELD STRENGTH 450MPa ULTIMATE TENSILE STRENGTH, ALL HELIX MATERIAL TO BE GRADE 44W-310MPa YIELD STRENGTH 4. CONTRACTRO TO SUPPLY CALIBRATION LOAD SHEET TO CONSULTANT FOR REVIEW & APPROVAL
- **UPON REQUEST** 5. SCREW PILES ARE ACCEPTED AS DEEP FOUNDATION UNITS
- N.B.C.C. A-4.2.7.1 6. FIELD WELDED STEEL PILE SHAFT TO TELESCOPIC SHAFT, FIELD CONFIRM ELEVATIONS
- 7. CONTRACTOR TO FIELD CONFIRM TOP ELEVATIONS OF ALL SCREW PILES
- 8. COORDINATE PILE LOCATIONS & ELEVATIONS WITH MODULAR SUPPLIER/INSTALLER 9. PILE MANUFACTURER MUST BE CERTIFIED WITH CANADIAN WELDING BUREAU (C.W.B.) TO C.S.A.
- STANDARD W47.1 10. ALL TEST PILES USED TO PROVIDE PILE CAPACITES MUST BE TESTED IN ACCORDANCE WITH THE
- ASTM STANDARDS INDIVIDUAL/GROUP 11. A SHOP DRAWING MUST BE PROVIDED INDICATING ALL PILE SIZES, INCLUDING SHAFT DIAMETER, HELIX DIAMETER AND PILE LENGTH. THESE SHOP DRAWINGS MUST BE APPROVED AND SEALED BY
- A QUALIFIED ENGINEER REGISTERED IN THE PROVINCE OF JURISDICTION 12. GEOTECHNICAL PARAMETER ARE BASED ON THE CFEM 4th EDITION, THE SPECIFIC GEOTECHNICAL PARAMETERS TO BE REVIEWED AND CONFIRMED BY A PROFESSIONAL GEOTECHNICAL ENGINEER
- RETAINED BY THE INSTALLER PRIOR TO INSTALLATION 13. INSTALL TO BE MONITORED BY A PROFESSIONAL GEOTECHNICAL ENGINEER
- 14. TORQUE CORRELATION FACTOR BASED ON CFEM RECOMMENDATION, ACTUAL CORRELATION FACTOR TO BE CONFIRMED BY INSTALLER LOAD TEST DATA CHART

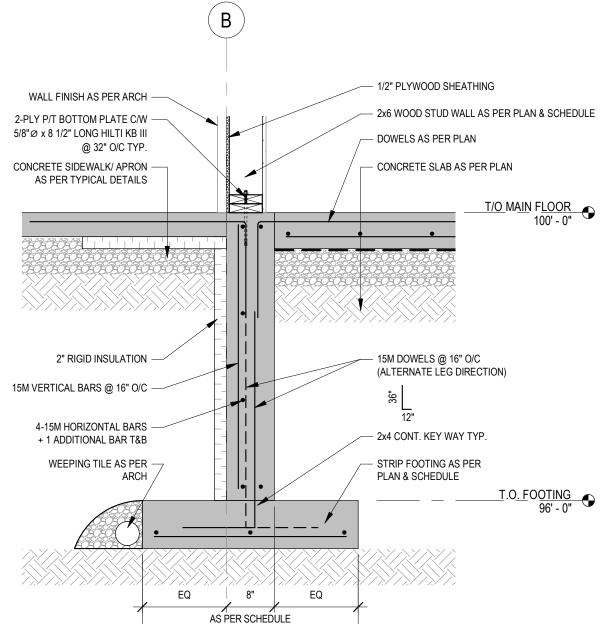

3 FOUNDATION SECTION S1.1 / 3/4" = 1'-0"

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ADDITIONAL WORK. IN THE CASE OF A DISCREPANCY BETWEEN THE CONTRACT T/O MAIN FLOOR

100' - 0"

IN THE CASE OF A DISCREPANCE DETAYLER THE CONTROL OF DOCUMENTS, DRAWINGS OF LARGER SCALE SHALL GOVERN OVER

DOCUMENTS, DRAWINGS OF LARGER SCALE SHALL GOVERN THOSE OF SMALLER SCALE, - SPECIFICATIONS SHALL GOVERN

IMMEDIATELY. FAILURE TO DO SO SHALL NOT BE GROUNDS FOR

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TENDER

OVER DRAWINGS.

REVISION SCHEDULE ISSUED FOR:

2020.05.20

2020.06.02

CLEARHILLS COUNTY

CLEARHILLS FIREHALL


SITE DESCRIPTION: LOT 84 & 85, BLOCK 1, PLAN 07262595, CLEARDALE, CLEARHILLS COUNTY, AB


FOUNDATION PLAN &

DETAILS

DRAWN BY: GB PROF. REVIEW: TECH. REVIEW: JW FINAL REVIEW: SPA PROJECT NUMBER: DRAWING NUMBER:



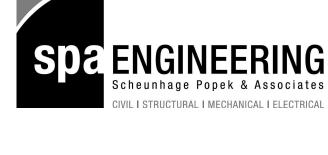


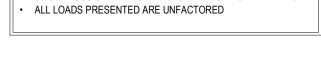

DEAD LOAD = 0.5 kPa = 0.6 kPa (JOIST / TRUSS SELF WEIGHT INCLUDED) LIVE LOAD = 4.8 kPa

JOIST/TRUSS SELF WEIGHT INCLUDED IN UNIFORM DEAD LOAD.

FLOOR LOADS

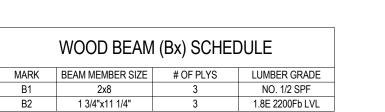

2. FLOOR TRUSSES SHALL BE DESIGNED FOR A MAXIMUM LIVE LOAD DEFLECTION OF L/360.

6. COORDINATE ALL DUCT OPENING SIZES & LOCATIONS WITH MECHANICAL. ALL DIMENSIONS AND

7. 'BX' ON PLANS DENOTES WOOD BEAM. REFER TO THE WOOD BEAM SCHEDULE ON THIS SHEET. 8. 'Gx' ON PLANS DENOTES WOOD COLUMN. REFER TO THE WOOD COLUMN SCHEDULE ON THIS SHEET. 9. ALL TRUSS BRACING AND ASSOCIATED CONNECTIONS ARE TO BE DESIGNED BY THE TRUSS

10. PROVIDE SHOP DRAWINGS FOR ALL TRUSSES. SHOP DRAWINGS SHALL BE SIGNED AND SEALED BY A P. ENGINEER. TRUSS SUPPLIER'S ENGINEER TO INSPECT ALL TRUSSES ONCE INSTALLED AND VERIFY

11. PROVIDE SHOP DRAWINGS FOR ALL TRUSS CONNECTIONS. UNLESS OTHERWISE NOTED ALL CONNECTIONS TO BE DESIGNED BY THE SUPPLIER. ALL SHOP DRAWINGS SHALL BE SIGNED AND

13. CONTRACTOR TO PROVIDE FLEXIBLE CONNECTION BETWEEN NON LOAD BEARING WALLS AND FLOOR

12. PROVIDE SHOP DRAWINGS FOR ALL LVL BEAMS AND THEIR CONNECTIONS. UNLESS NOTED OTHERWISE ALL CONNECTIONS REQUIRED FOR LVL BEAMS SHALL BE DESIGNED AND SUPPLIED BY

14. U.N.O. BY SUPPLIER INSTALL TIE DOWN CLIPS AT ALL FLOOR TRUSS BEARING LOCATIONS.

3. CONTRACTOR TO CONFIRM ALL DIMENSIONS PRIOR TO COMMENCING WORK.

4. JOIST SPACING NOT TO EXCEED 16" O/C. DECREASE SPACING IF REQUIRED. 5. FRAME OPENINGS AS REQUIRED FOR ACCESS AND MECHANICAL DUCT OPENINGS.

ELEVATIONS ARE TO BE VERIFIED PRIOR TO TRUSS FABRICATION.

TRUSSES ABOVE TO ALLOW FOR FLOOR TRUSS DEFLECTION.

15. U.N.O. TIE DOWN CLIPS TO BE SUPPLIED BY TRUSS SUPPLIER.

 FLUSH BEAMS ARE DESIGNATED BY AN 'F' (B#-F) ALL WOOD TO WOOD CONNECTIONS AS PER SUPPLIER

FLOOR FRAMING NOTES:

INSTALLATION IN WRITING.

SEALED BY A P. ENGINEER.

THE SUPPLIER.

1. U.S. FLOOR TRUSS BEARING ELEV. = 108'-8 1/4".

STUD WALL (SWx) SCHEDULE					
MARK	STUDS	SPACING	PLATES	BLOCKING	NOTES
SW1	2x6	16" O/C	2x6	48" O/C	SEE DETAIL 'A'

NOTES:
THE STUD WALL SCHEDULE APPLIES TO LOAD BEARING WALLS ONLY, REFER TO ARCH. FOR ALL OTHER STUD WALL TYPES.
WALL FRAMING LISTED IS TYPICAL UNLESS NOTED OTHERWISE. CONFIRM ALL

WALL TYPES WITH ARCH. EXTERIOR WALLS TO HAVE 1/2" PLYWOOD SHEATHING ON ONE SIDE SECURED USING 2 1/2" COMMON NAILS AT 4" O/C AT PANEL EDGES & 10" O/C AT INTERIOR

GANG STUD (Gx) SCHEDULE					
MARK	MEMBER SIZE	NO. OF PLYS	LUMBER GRADE		
G1	2x6	2	NO.1/2 SPF		
G2	2x6	3	NO.1/2 SPF		
G3	2x6	4	NO.1/2 SPF		

NOTES: ALL GANG STUDS TO BE SPF #2 OR BETTER.

 ALL LINTELS TO BE SUPPORTED BY 2-CONTINUOUS STUDS ON MAIN FLOOR & 1-CONTINUOUS STUD ON ALL OTHER FLOORS IN ADDITION TO GANG STUDSSPECIFIED IN PLAN.

 ALL WOOD COLUMNS TO BE CONTINUOUS TO THE FND. FROM THE FLOOR/ROOF PLAN INDICATED. MINIMUM SUPPORT AT LINTELS IS 2-PLY GANGED STUD TO MATCH WALL SIZE U.N.O.

ROOF FRAMING NOTES:

1. U.S. ROOF TRUSS BEARING ELEV. = 116'-0". 2. ROOF TRUSSES SHALL BE DESIGNED FOR A MAXIMUM LIVE LOAD DEFLECTION OF L/360.

3. CONTRACTOR TO CONFIRM ALL DIMENSIONS PRIOR TO COMMENCING WORK. 4. TRUSS SPACING NOT TO EXCEED 24" O/C. DECREASE SPACING IF REQUIRED. 5. FRAME OPENINGS AS REQUIRED FOR ACCESS AND MECHANICAL DUCT OPENINGS.

6. COORDINATE ALL DUCT OPENING SIZES & LOCATIONS WITH MECHANICAL. ALL DIMENSIONS AND ELEVATIONS ARE TO BE VERIFIED PRIOR TO TRUSS FABRICATION. 7. 'Bx' ON PLANS DENOTES WOOD BEAM. REFER TO THE WOOD BEAM SCHEDULE ON THIS SHEET.

9. ALL TRUSS BRACING AND ASSOCIATED CONNECTIONS ARE TO BE DESIGNED BY THE TRUSS 10. PROVIDE SHOP DRAWINGS FOR ALL TRUSSES. SHOP DRAWINGS SHALL BE SIGNED AND SEALED BY

8. 'Gx' ON PLANS DENOTES WOOD COLUMN. REFER TO THE WOOD COLUMN SCHEDULE ON THIS SHEET.

A P. ENGINEER. TRUSS SUPPLIER'S ENGINEER TO INSPECT ALL TRUSSES ONCE INSTALLED AND VERIFY INSTALLATION IN WRITING. 11. PROVIDE SHOP DRAWINGS FOR ALL TRUSS CONNECTIONS. UNLESS OTHERWISE NOTED ALL CONNECTIONS TO BE DESIGNED BY THE SUPPLIER. ALL SHOP DRAWINGS SHALL BE SIGNED AND

SEALED BY A P. ENGINEER. 12. PROVIDE SHOP DRAWINGS FOR ALL LVL BEAMS AND THEIR CONNECTIONS. UNLESS NOTED OTHERWISE ALL CONNECTIONS REQUIRED FOR LVL BEAMS SHALL BE DESIGNED AND SUPPLIED BY THE SUPPLIER.

13. CONTRACTOR TO PROVIDE FLEXIBLE CONNECTION BETWEEN NON LOAD BEARING WALLS AND ROOF TRUSSES ABOVE TO ALLOW FOR ROOF TRUSS DEFLECTION. 14. U.N.O. BY SUPPLIER INSTALL TIE DOWN CLIPS AT ALL ROOF TRUSS BEARING LOCATIONS. 15. U.N.O. TIE DOWN CLIPS TO BE SUPPLIED BY TRUSS SUPPLIER. WATER RETENTION ON ROOF IS NOT

ROOF LOADS

DEAD LOAD = .75 kPa = 1.0 kPa (JOIST / TRUSS SELF WEIGHT INCLUDED) LIVE LOAD = 1.0 kPa

SNOW LOAD = 2.53 kPa JOIST/TRUSS SELF WEIGHT INCLUDED IN UNIFORM DEAD LOAD. ALL LOADS PRESENTED ARE UNFACTORED

NOTES

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THOSE OF SMALLER SCALE, - SPECIFICATIONS SHALL GOVERN OVER DRAWINGS. THESE DRAWINGS ARE NOT TO BE USED FOR CONSTRUCTION

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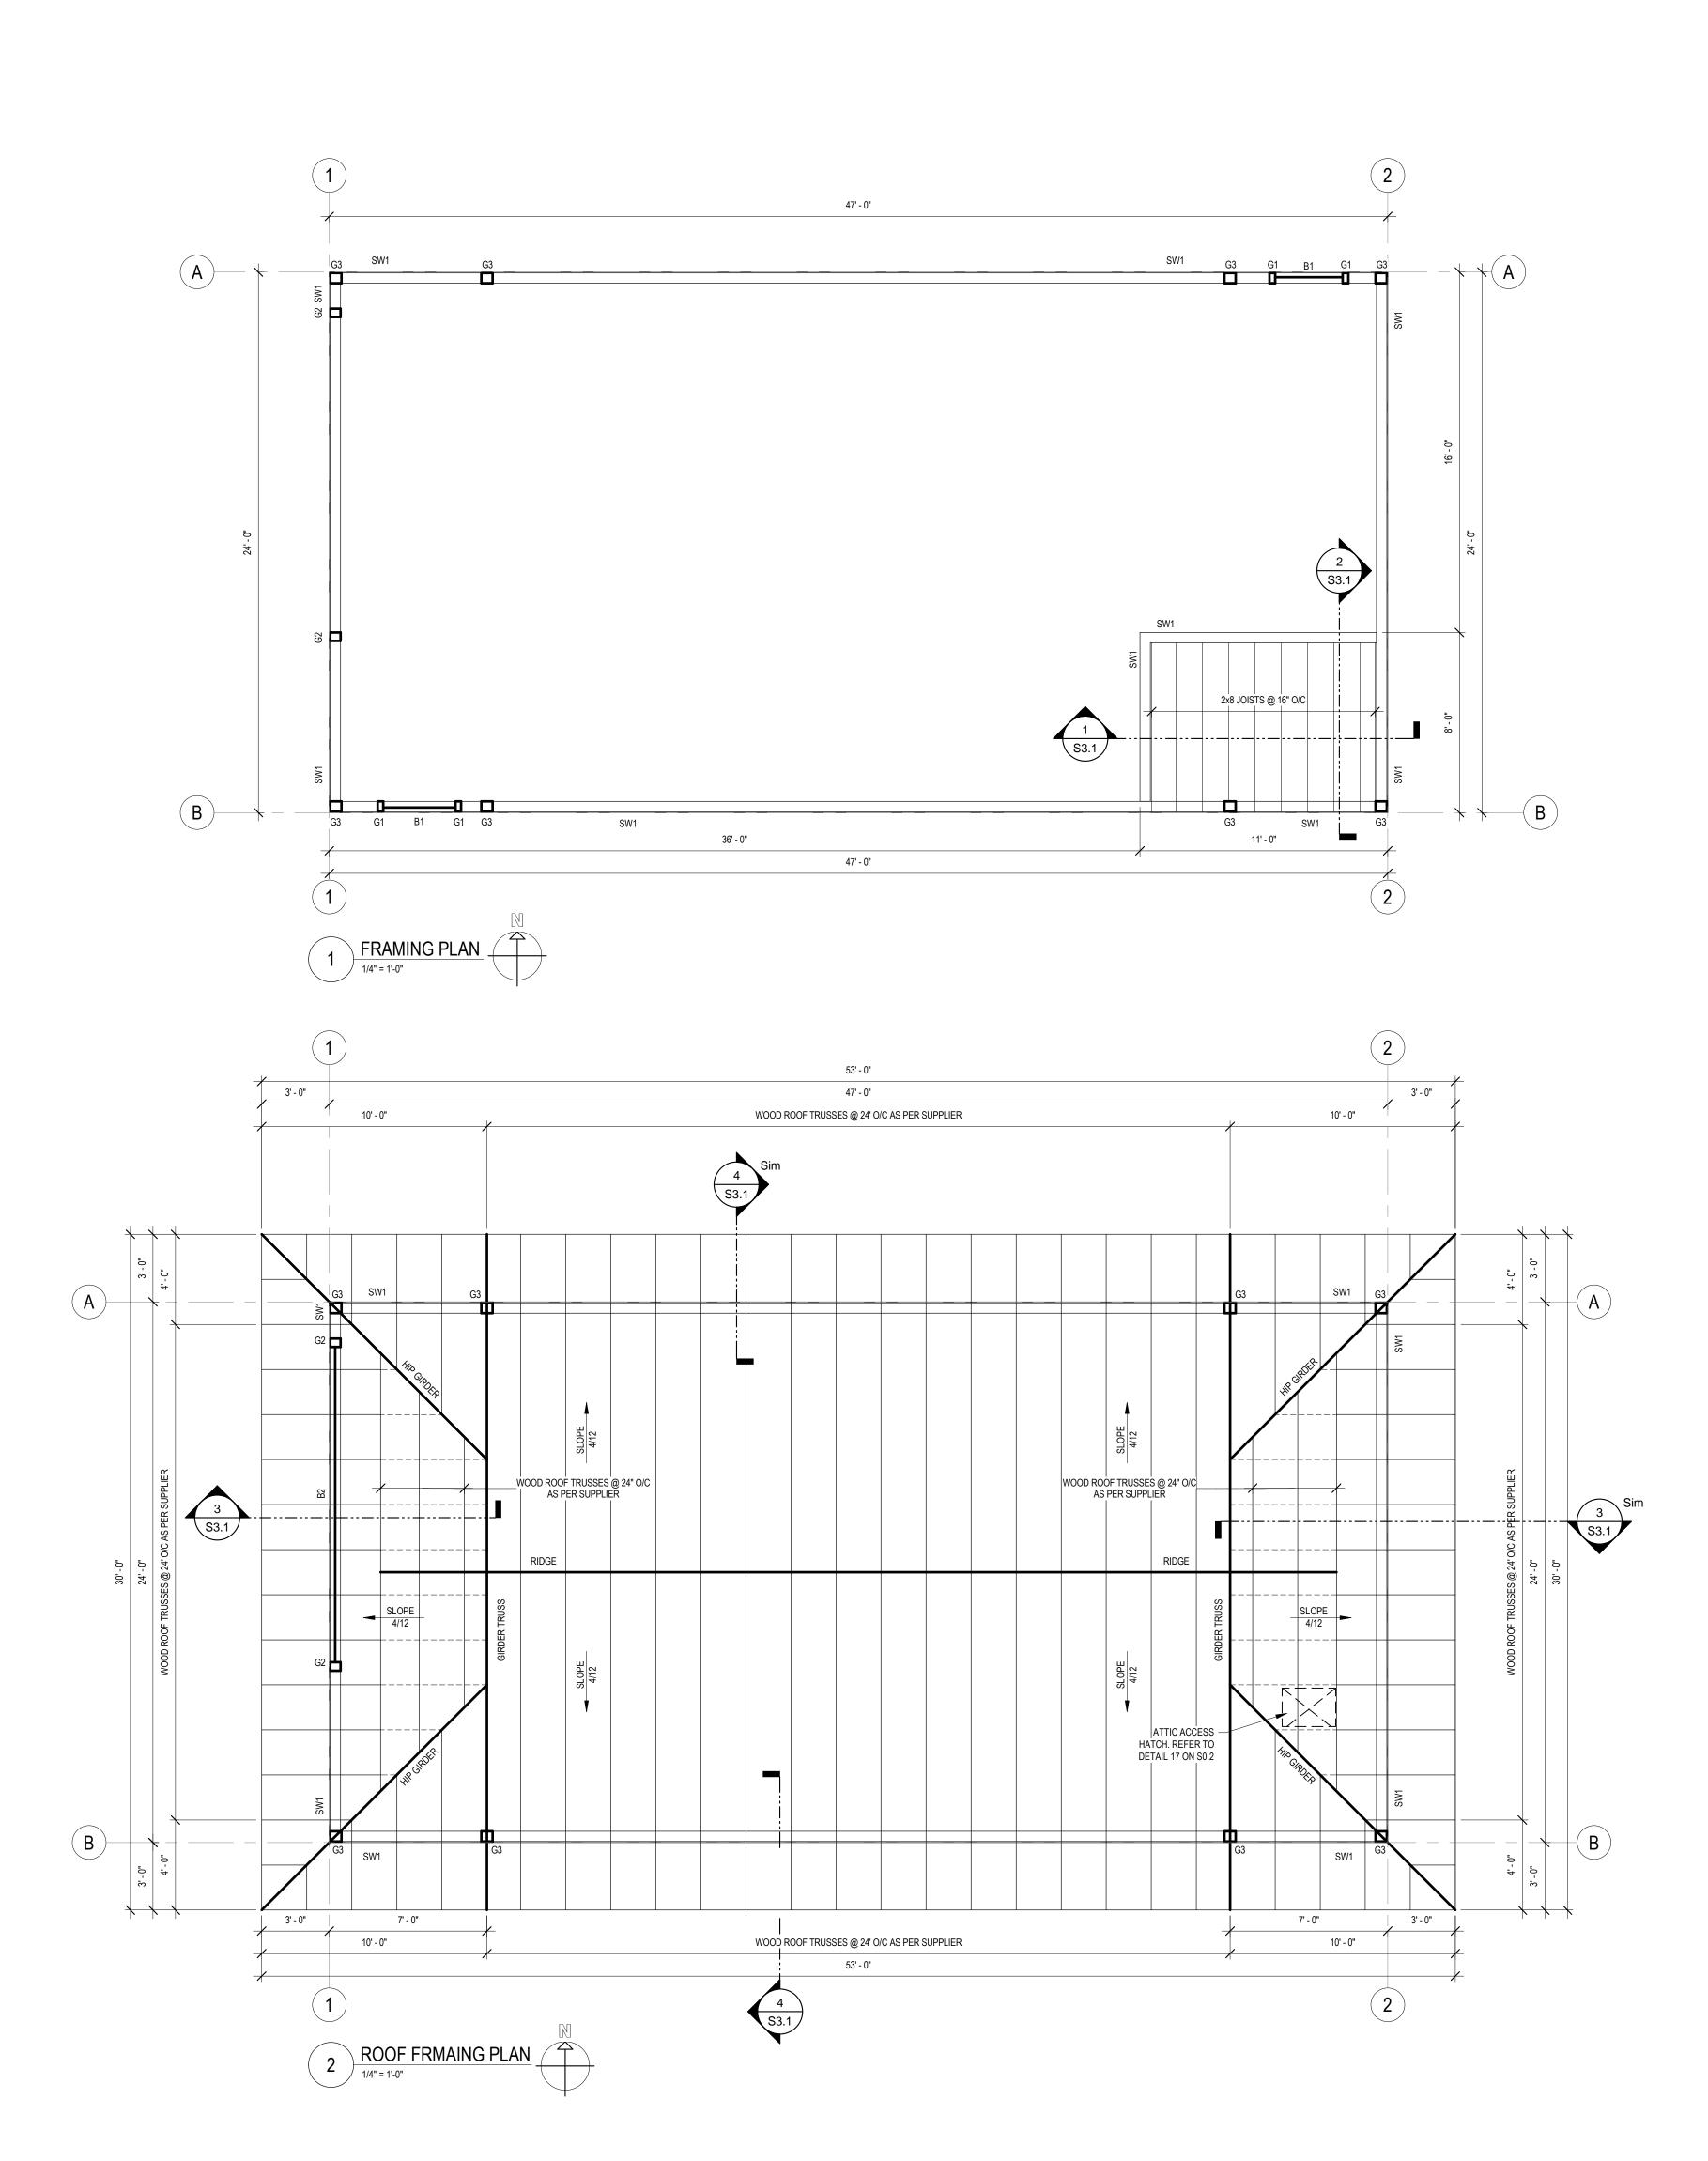
CLEARHILLS COUNTY


CLEARHILLS FIREHALL


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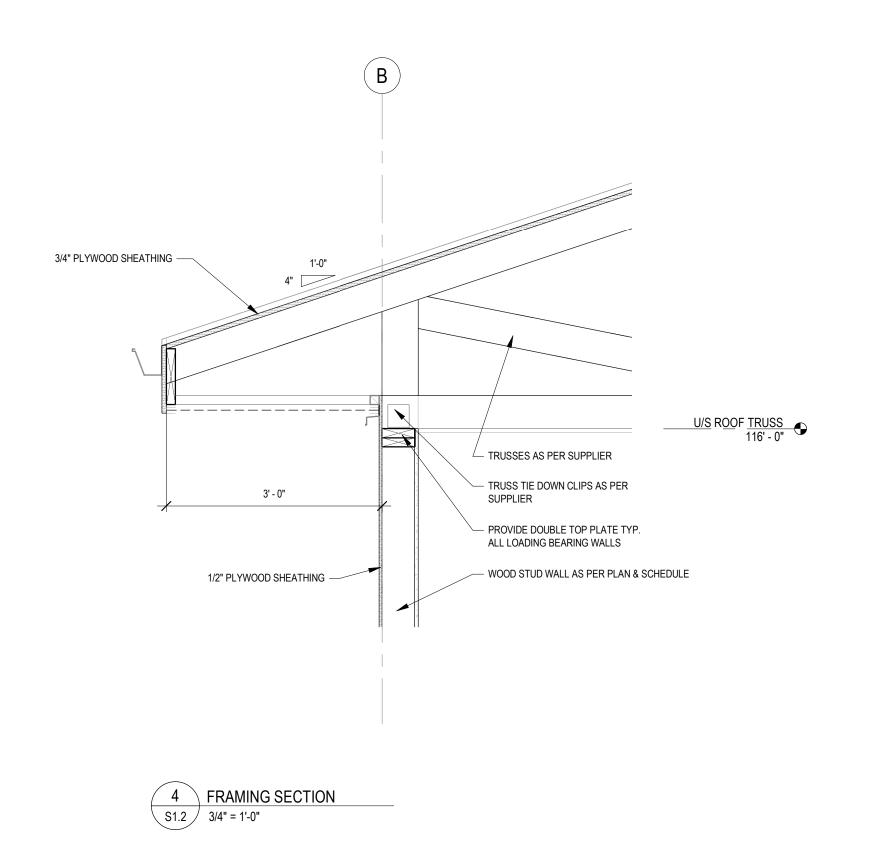
FRAMING PLANS

DRAWN BY:	GB	PROF. REVIEW:	1
TECH. REVIEW:	JW	FINAL REVIEW:	1
SPA PROJECT NUMBER:			20-0





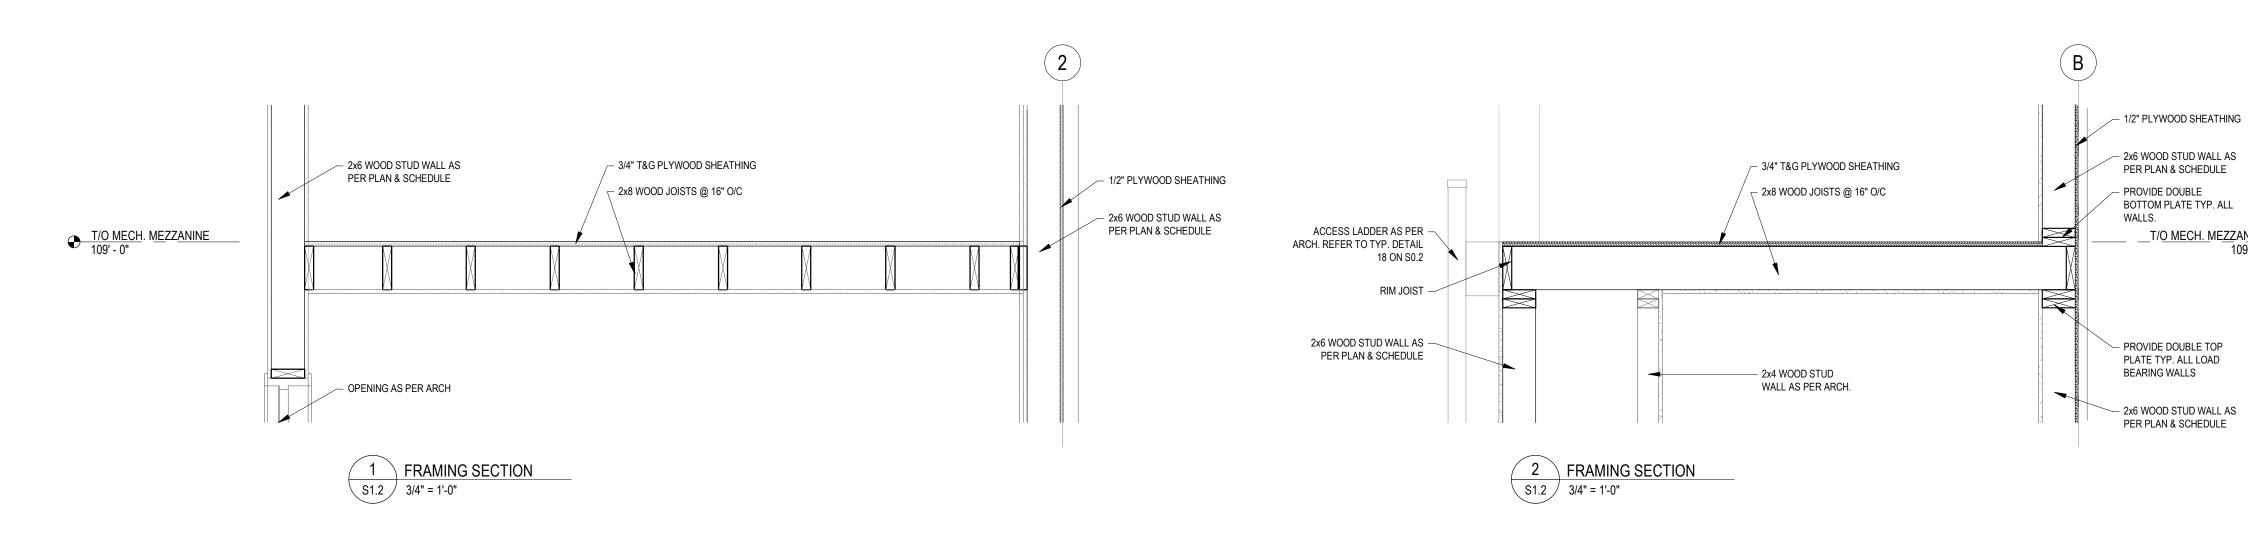

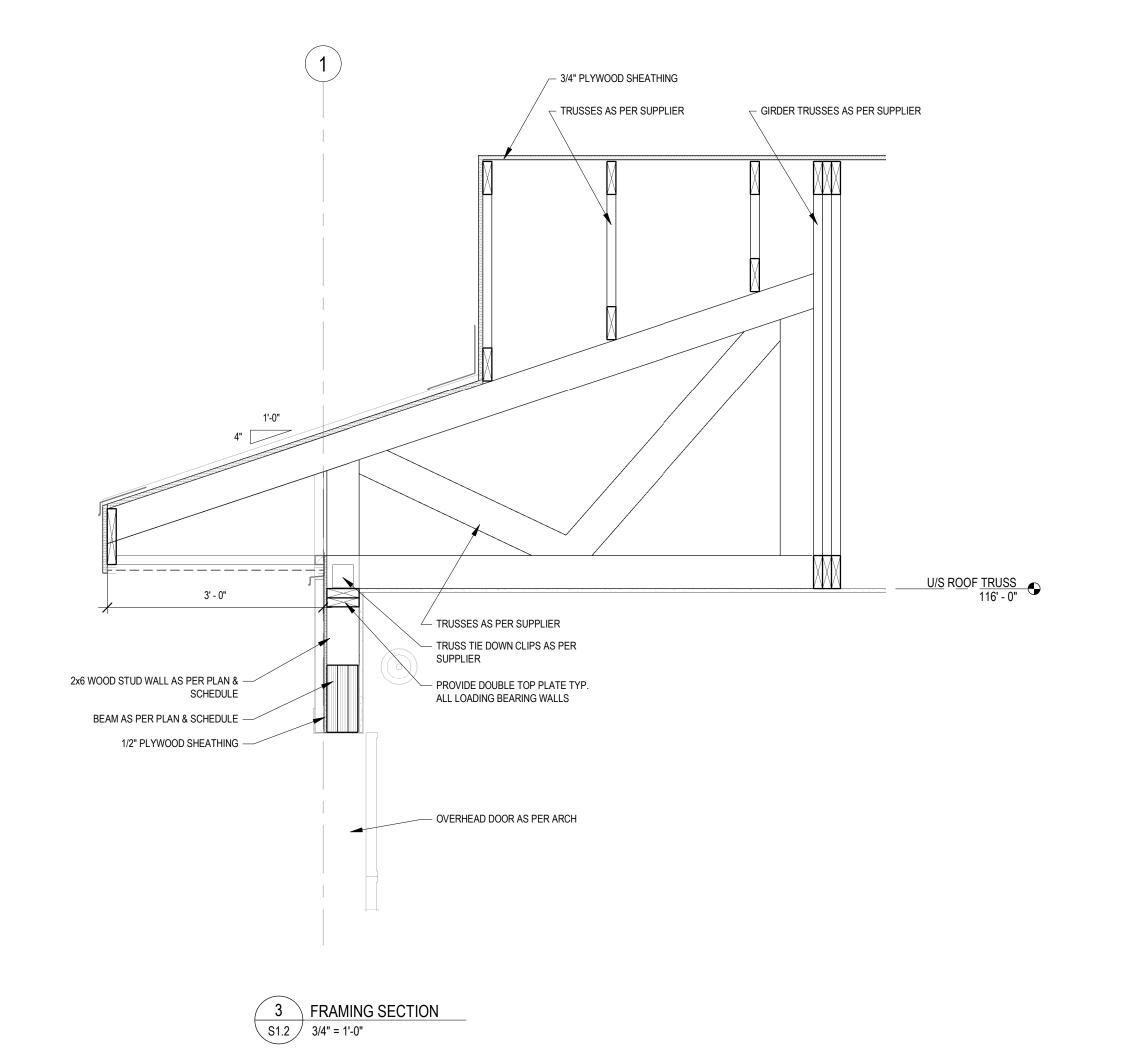

NOTES
DO NOT

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PROF. SEAL:

REVISIO	REVISION SCHEDULE					
ISSUED FOR:	REVISION	DATE				
90% CLIENT REVIEW TENDER	C 0	2020.05.20 2020.06.02				

CLEARHILLS COUNTY

PROJECT:

CLEARHILLS FIREHALL

SITE DESCRIPTION: LOT 84 & 85, BLOCK 1, PLAN 07262595, CLEARDALE, CLEARHILLS COUNTY, AB

FRAMING SECTIONS

DD 414/01/0 4 U II 4D ED			DE: ((0)0)	
SPA PROJECT NUMBER:				20-04
TECH. REVIEW:	JW	FINAL REVIE	W:	В
DRAWN BY:	GB	PROF. REVIE	EW:	В

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